GOLD MEDAL LOFTS

MILWAUKEE | MADISON | TUCSON | CHICAGO



225 E. Michigan St., Suite 110 Milwaukee, WI 53202 T: 414-501-5610 F: 414-755-0617

GOLD MEDAL LOFTS

1701 Packard Avenue Racine, WI 53403

ISSUED FOR:

FOR

100% SD SET - NOT CONSTRUCTION

NPS / SHPO REVISION FOR:

ARCHITECTURAL ENGBERG ANDERSON

RACINE, WISCONSIN

APPROVALS LOG DESCRIPTION JURISDICTION DATE

09-14-2018

DATE

D140 ROOF DEMOLITION PLAN

GENERAL INFORMATION CODE COMPLIANCE CODE COMPLIANCE
CODE COMPLIANCE
ROOF PLAN
ENLARGED UNIT PLANS
ENLARGED UNIT PLANS
ENLARGED UNIT PLANS ENLARGED UNIT PLANS ENLARGED UNIT PLANS **ENLARGED UNIT PLANS** ENLARGED UNIT PLANS ENLARGED UNIT PLANS

ENLARGED UNIT PLANS ENLARGED UNIT PLANS ENLARGED UNIT PLANS ENLARGED UNIT PLANS ENLARGED UNIT PLANS ENLARGED UNIT PLANS ENLARGED UNIT PLANS

ENLARGED UNIT PLANS ENLARGED UNIT PLANS ENLARGED UNIT PLANS ENLARGED UNIT PLANS ENLARGED UNIT PLANS ENLARGED TYPE-A PLANS

ELEVATIONS SECTION DETAILS
WALL TYPES
EXISTING WINDOW CONDITION PLAN
EXISTING WINDOW CONDITION PLAN

WS120 EXISTING WINDOW CONDITION PLAN EXISTING WINDOW CONDITION PLAN DEMOLITION / REPOINTING ELEVATIONS WS401 WS520 WS521 WS600 WS601 DEMOLITION / REPOINTING ELEVATIONS EXISTING WINDOW DETAILS

EXISTING WINDOW DETAILS WINDOW TYPES EXISTING CONDITIONS

INCLUDED

REHABILITATION OF THE HISTORICAL GOLD MEDAL FURNITURE COMAPNY.





LOCATION MAP

DRAWN BY CHECKED BY

TITLE SHEET

G101





225 E, Michigan St., Suite 110 Milwaukee, WI 53202 T: 414-501-5610 F: 414-755-0617

GOLD MEDAL LOFTS

PROJECT NUMBER

ISSUED FOR: NPS / SHPO

09-14-2018


172792,00

REVISION FOR: NO. DESCRIPTION

DATE

CHECKED BY

EXISTING WINDOW CONDITION PLAN

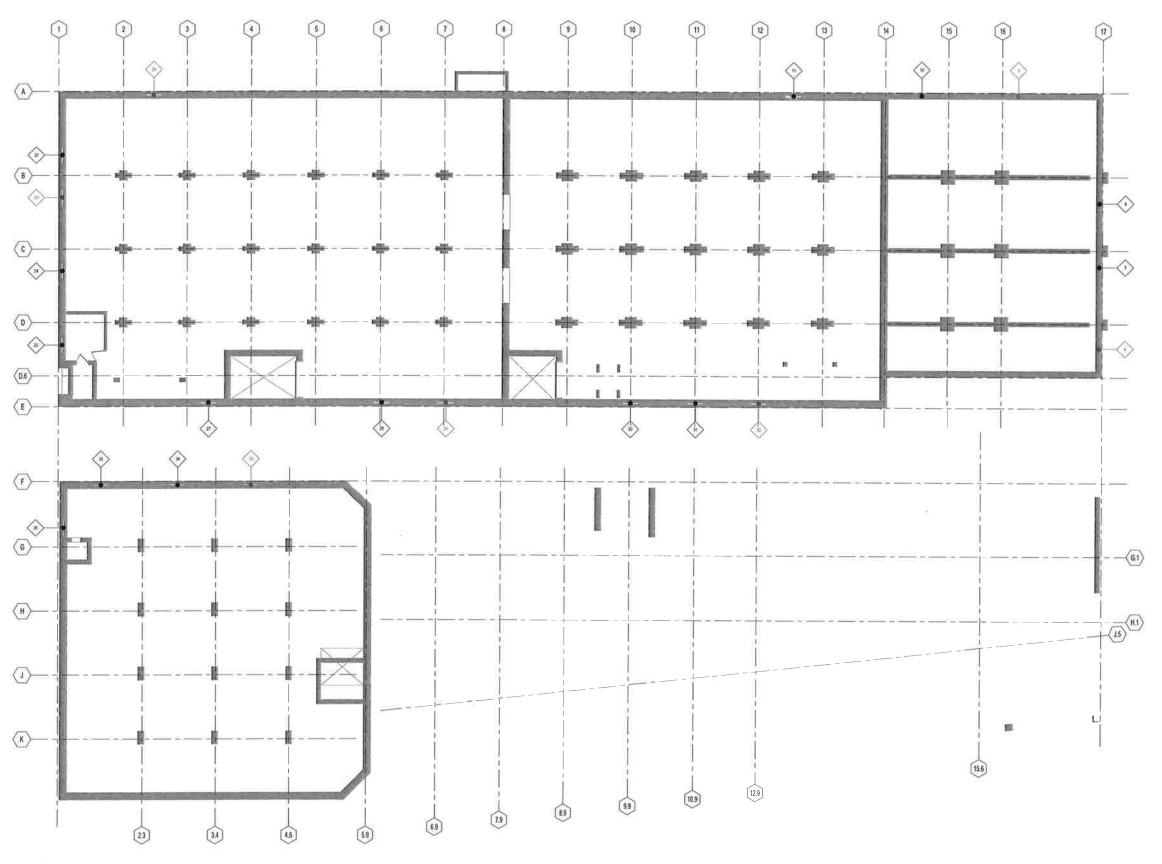

EXISTING BASEMENT
SCALE: 1/8° = 1'-0"

MILWAUKEE | MADISON | TUCSON | CH



225 E. Michigan St., Suite 110 Milwaukee, WI 53202 T: 414-501-5610 F: 414-755-0617

GOLD MEDAL LOFTS

1701 Packard Avenue Reclne, WI 53403

PROJECT NUMBER


172792 00

ISSUED FOR:	
NPS / SHPO	09-14-201
REVISION FOR:	DATE
NO. DESCRIPTION	DAIL

DRAWN BY

CHECKED BY

EXISTING WINDOW CONDITION PLAN

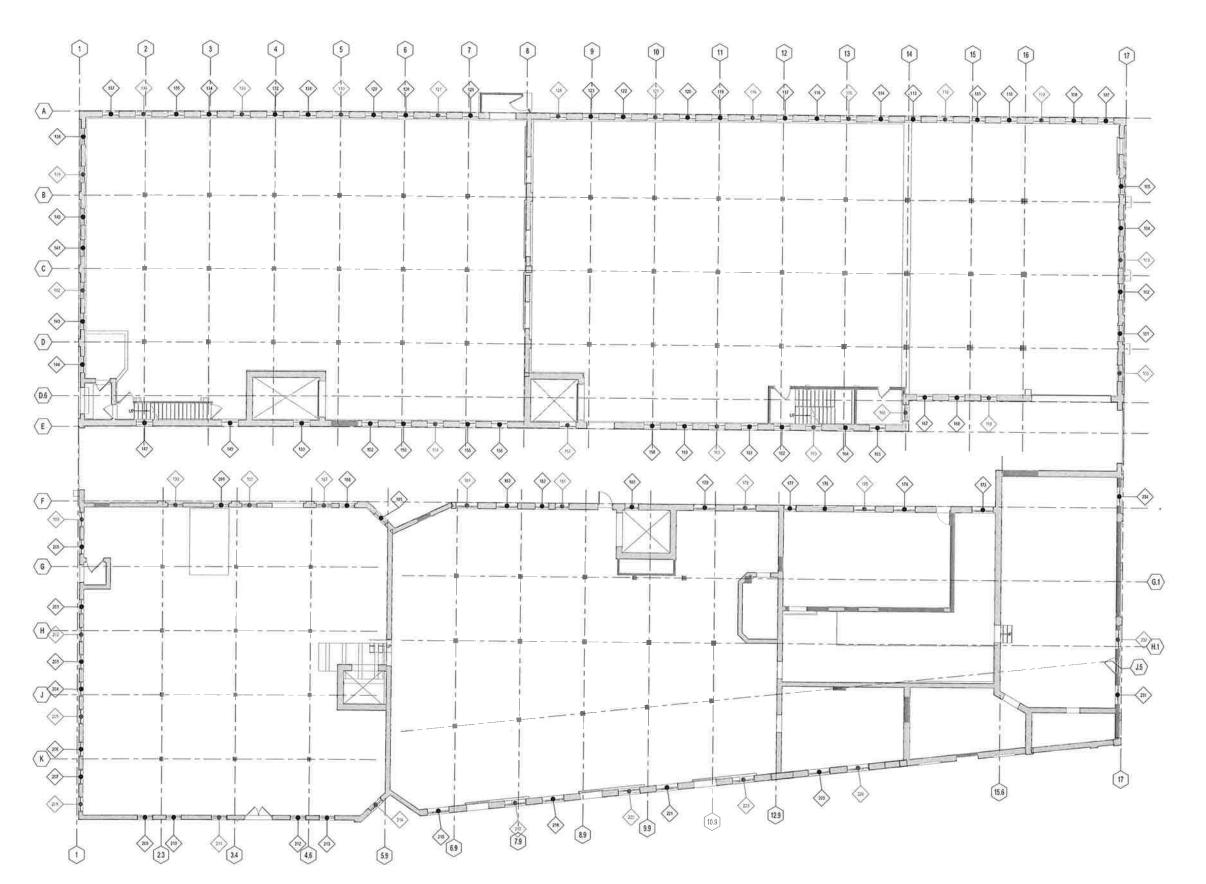

EXISTING LEVEL 1
SCALE: 1/8" = 1'-0"



MILWAUKEE | MADISON | TUCSON | CHICA



225 E. Michigan St., Suite 110 Milwaukee, WI 53202 T: 414-501-5610 F: 414-755-0617

GOLD MEDAL LOFTS


1701 Packard Avenue Racine, WI 53403

PROJECT NUMBER 17

ISSUED FOR:	
NPS / SHPO	09-14-201
REVISION FOR:	DATE
NO. DESCRIPTION	

DRAWN BY Author
CHECKED BY Checker

EXISTING WINDOW CONDITION PLAN

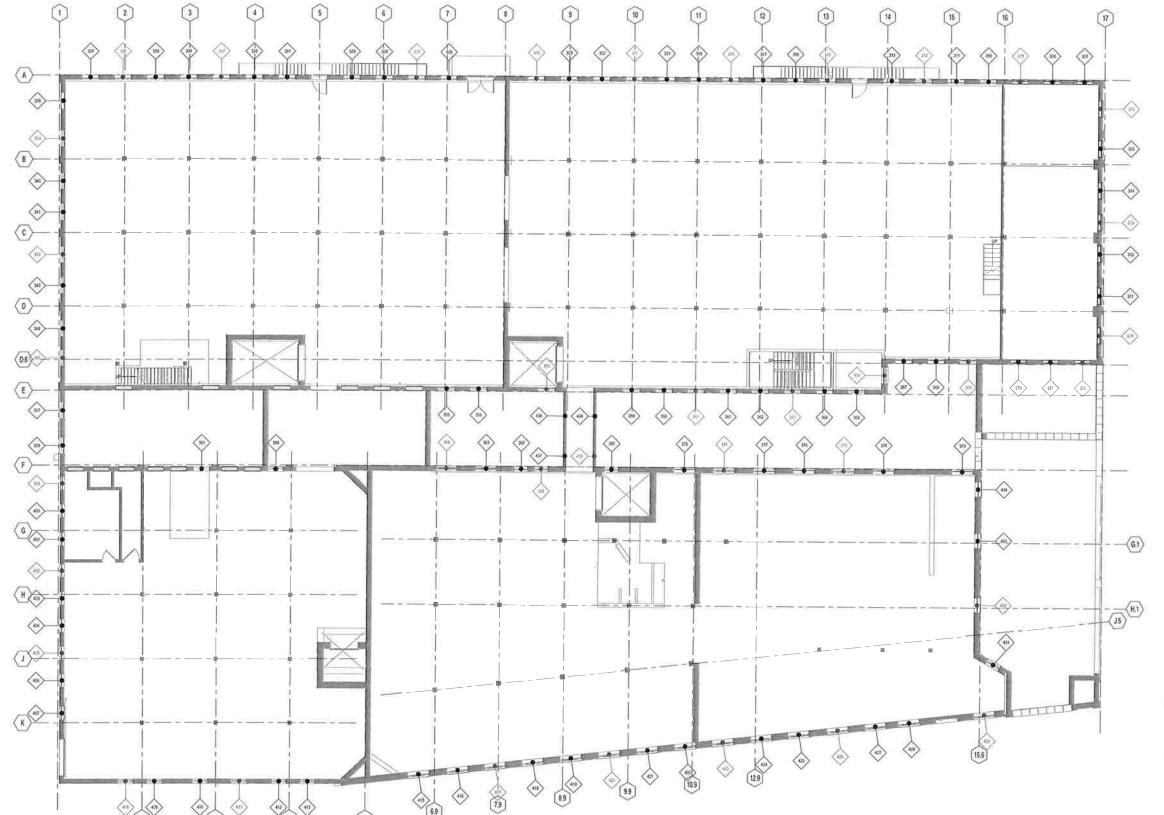



MILWAUKEE | MADISON | TUCSON | CHICA



225 E. Michigan St., Suite 110 Milwaukee, WI 53202 T: 414-501-5610 F: 414-755-0617

GOLD MEDAL LOFTS

1701 Packard Avenue Racine, WI 53403

PROJECT NUMBER

ISSUED FOR:	
NPS / SHPO	09-14-2018
REVISION FOR:	DATE
NO DESCRIPTION	DATE

-(a)

DRAWN BY Aul
CHECKED BY Chec

-(G.1)

+(15)(H.1)

EXISTING WINDOW CONDITION PLAN

EXISTING LEVEL 3
SCALE: 1/8" = 1'-0"

23

34

4.6

(2)

 $\langle A \rangle$

(a)

(B)

(io)

(sa)

(D.6)(14)

(E)-

(F)-

(G)-

(H)-

 $\langle K \rangle$

(C)—

3

6

(19)

√(8)

59

(8)


9


10


(1)

(12)

(3)

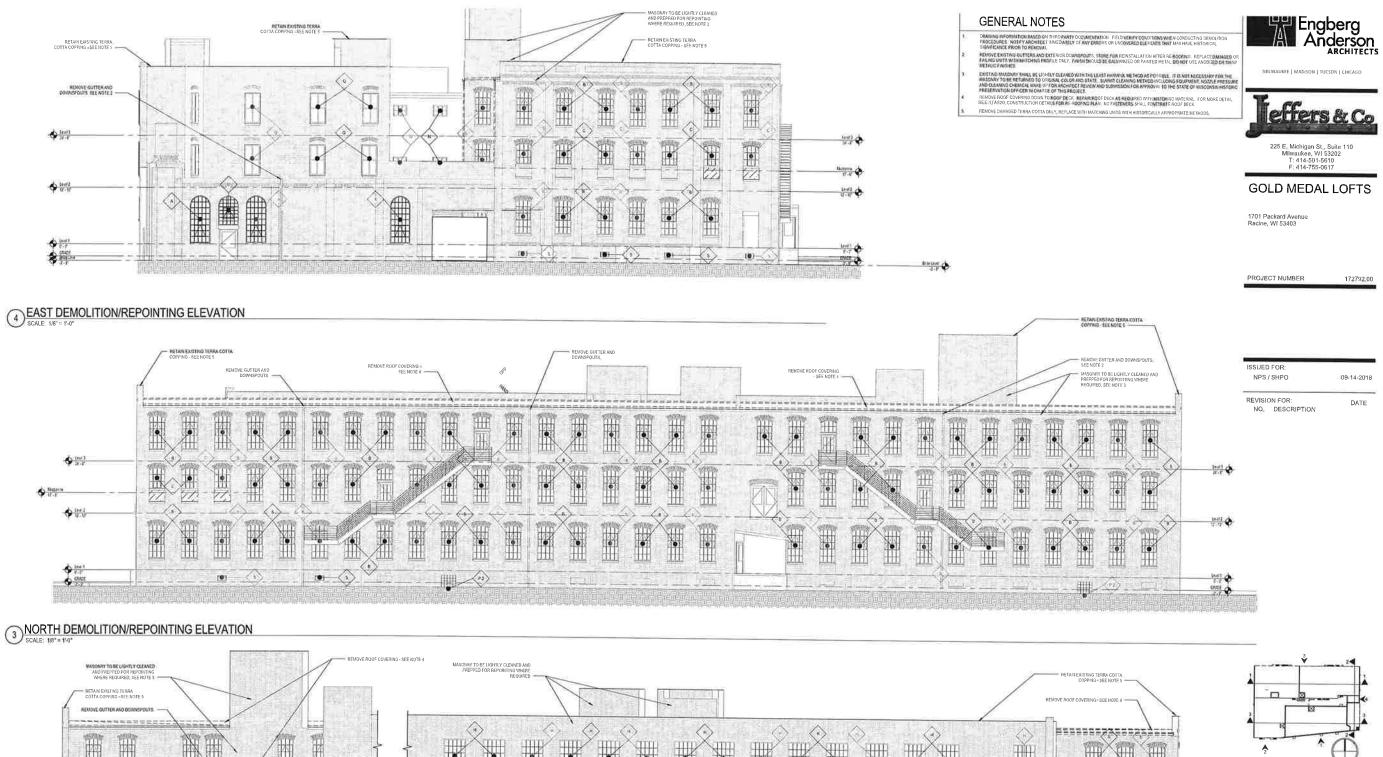

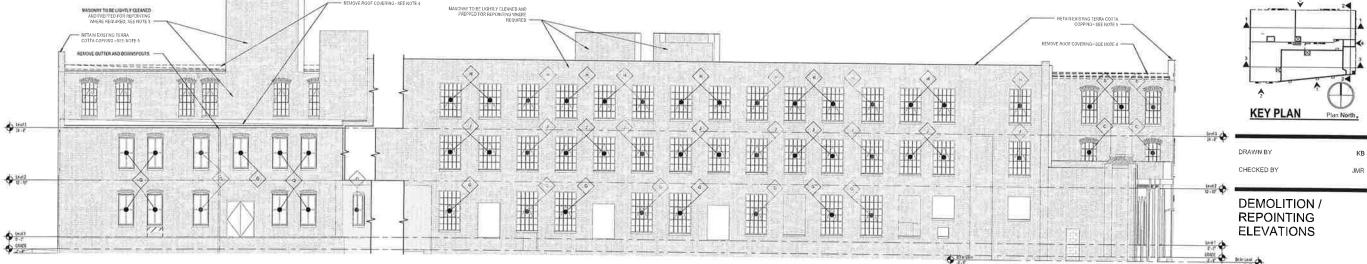

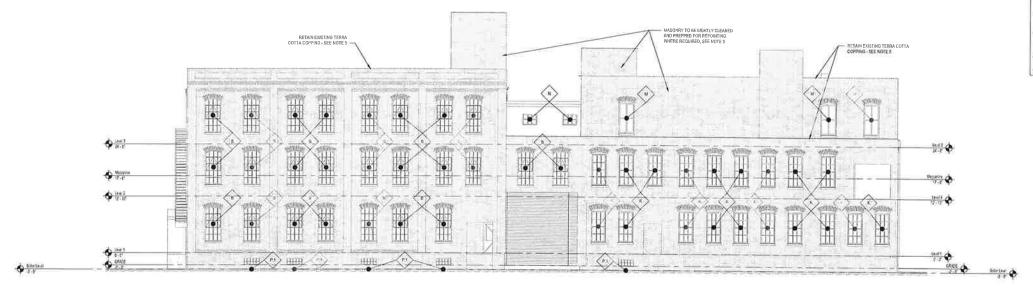

GENERAL NOTES

AGED TERRA COTTA ONLY, REPLACE WITH MATCHING UNITS WITH HISTORICALLY APPROPRIATE METHOD





225 E, Michigan St., Sulte 110 Mllwaukee, WI 53202 T: 414-501-5610 F: 414-755-0617

GOLD MEDAL LOFTS

1701 Packard Avenue Racine, WI 53403

PROJECT NUMBER

It if C


Witterns Co Ir il O


172792.00

NPS / SHPO 09-14-2018 REVISION FOR:

NORTH ALLEY COURT DEMOLITION ELEVATION SCALE: 188" = 11:0"

2 WEST DEMOLITION ELEVATION
SCALE: 1/8°= 1/40°

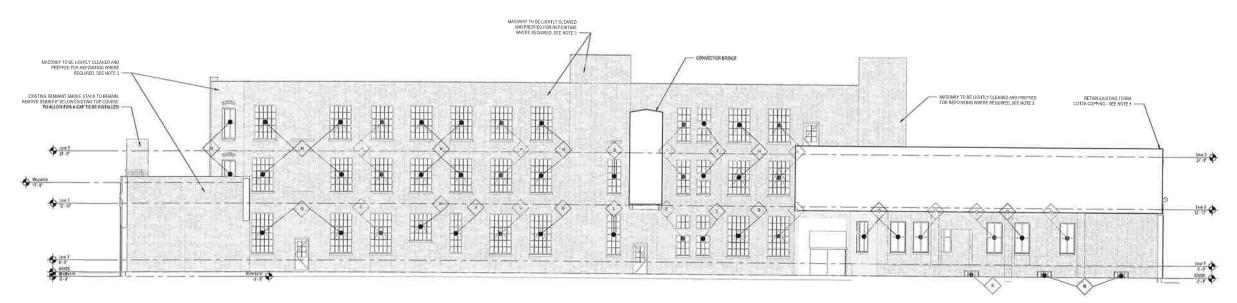


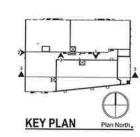


DRAWN BY CHECKED BY

DEMOLITION / REPOINTING **ELEVATIONS**


WS401

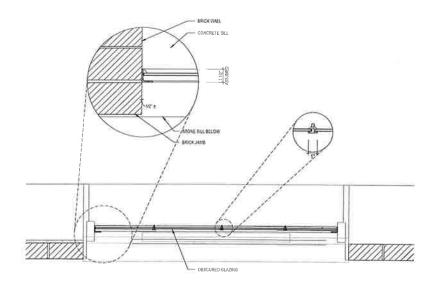


3 EXISTING STEEL SASH WINDOW, SOUTH SCHEMATIC

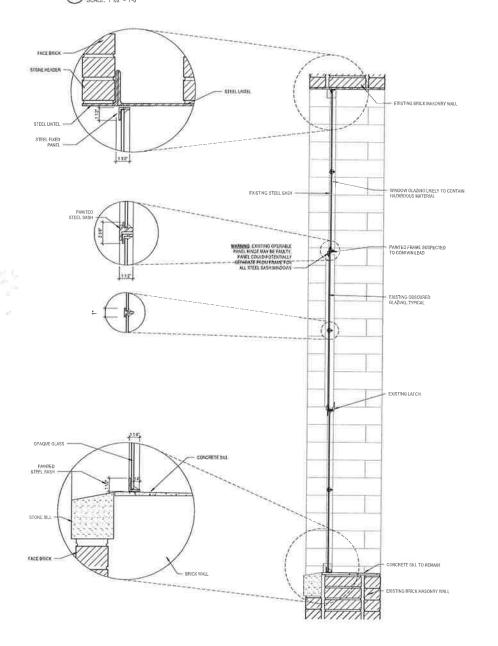



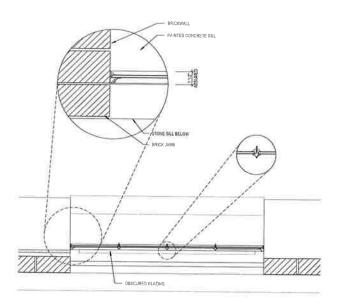

$\underbrace{\text{EXISTING STEEL SASH WINDOW, NORTH SCHEMATIC}}_{\text{SCALE: }11/2^* = 9 \cdot 9^*}$

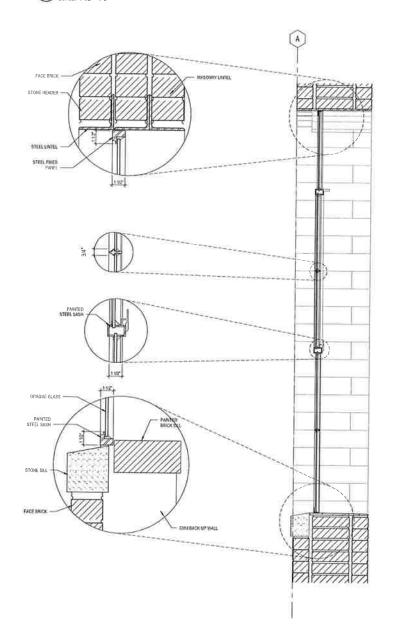



MILWAUKEE | MADISON | TUCSON | CHICA



225 E, Michigan St., Suite 110 Mllwaukee, WI 53202 T: 414-501-5610 F: 414-755-0617

GOLD MEDAL LOFTS


1701 Packard Avenue Racine, WI 53403


PROJECT NUMBER

ISSUED FOR:	
NPS / SHPO	09-14-2018
REVISION FOR:	DATE

DRAWN BY Aut
CHECKED BY Chec

EXISTING WINDOW DETAILS

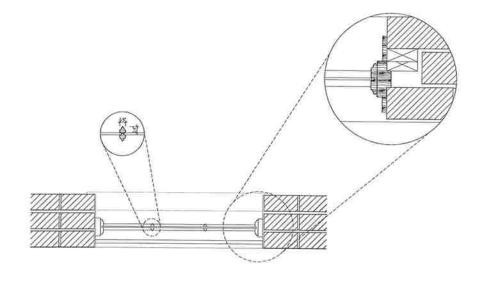

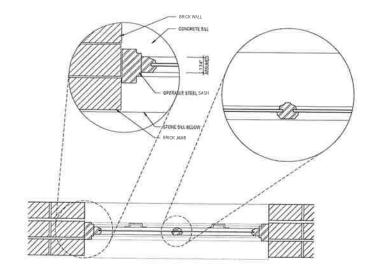

Engberg Anderson

MILWAUKEE | MADISON | TUCSON | CRIG



225 E, Michigan SI,, Sulle 110 Milwaukee, WI 53202 T: 414-501-5610 F: 414-755-0617

GOLD MEDAL LOFTS

1701 Packard Avenue Racine, WI 53403


PROJECT NUMBER


PROJECT NUMBER 172792

EXISTING WOOD SASH WINDOW SCHEMATIC

2 EXISTING STEEL SINGLE HUNG SCHEMATIC SCALE: 1 1/2"= 1"-0"

09-14-20
DATE

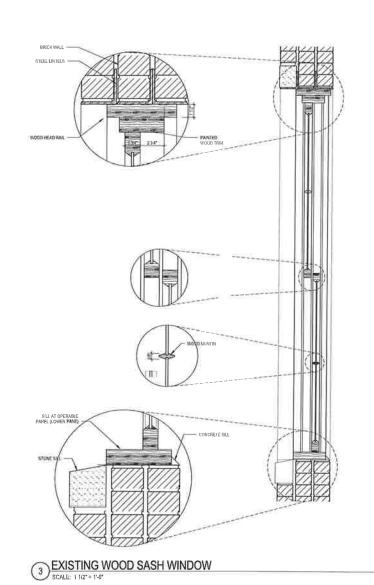

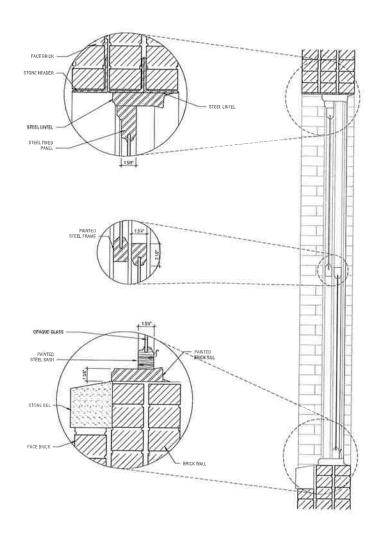

DRAWN BY Author CHECKED BY Checket

EXISTING WINDOW DETAILS

EXISTING STEEL SINGLE HUNG WINDOW SCALE: 1 1/2" = 1'-0"







Mllwaukee, WI 53202 T: 414-501-5610 F: 414-755-0617

GOLD MEDAL LOFTS

1701 Packard Aven


PROJECT NUMBER

172792,00

ISSUED FOR:	
NPS / SHPO	09-14-2018
REVISION FOR: NO. DESCRIPTION	DATE

FIELD VERIFY **** **** **** **** **** ***	3-7 3-8" ± FIELD VERIFY	FIELD VERIFY FIELD VERIFY	FELO VERBY	S.7. # FEED VESIEN TO SEE THE SEED VESIEN TO	Addition of the state of the st	S-0° ± FIELD VERIFY FIELD VERIFY	S-O* # FRELD VERDITY	S:0° ± FIELD VERIFY	FEID VERIEV
STEEL WINDOW TYPES SCALE: 1/2" = 1'-0"	(B)	<u></u>	⟨D⟩	⟨E ⟩	F	⟨G⟩	⟨Ĥ⟩	$\langle \hat{\mathbf{J}} \rangle$	⟨L⟩
SCALE: 1/2" = 1'-0"						Z-10" ± FIELD VERIFY			

Ť	3-6" ± FIELD VERIFY	3-6"± FIELD VERIFY				4-6-± FELD VERFY		5-0° ± FIELD VERIEY	
FELD USKIPY	7.0.* FRLAVEGEV		FELOVERY	FELD VERFY	FIELD VERIFY	FIELD VENIFY	FIELO VERIEV.	FIELD VENEY	FIELD VERIFY AGENTAL OF THE PROPERTY AGENTAL OF THE PROPERTY
	⟨M⟩	\oint{\oint}	⟨R⟩	(S)	⟨₹⟩	⟨ u ⟩	\Diamond	ŵ	$\stackrel{\sim}{\Longrightarrow}$
15) STEEL V SCALE: 1/2* = 1	/INDOW TYPES.								

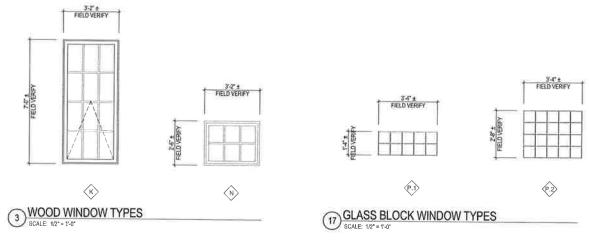

DRAWN BY AU
CHECKED BY Che

WINDOW TYPES

Engberg Anderson ARCHITECTS

MILWAUKEE | MADISON | TUCSON | CHICAGO



225 E, Michigan St., Suite 110 Milwaukee, WI 53202 T: 414-501-5610 F: 414-755-0617

GOLD MEDAL LOFTS

172792,00

PROJECT NUMBER

ISSUED FOR:	
NPS / SHPO	09-14-2018
REVISION FOR:	DATE

			3	Glazing	
WARK	7. 1.2.	Finish	MATERIAL	Туре	CONDITION
500	В	PAINTED	STL	WIRE/OBSCURED	SASHES RUSTED AND DETERIORATED, OPERABLE PANEL POTENTIALLY N
503	В	PAINTED	STL	WIRE/OBSCURED	
506	В	PAINTED	STL	WIRE/OBSCURED	
509	В	PAINTED	STL		SASHES RUSTED AND DETERIORATED, OPERABLE PANEL POTENTIALLY N STRUCTURALLY INTACT.
512	В	PAINTED	STL	CLEAR & OBSCURED	SASHES RUSTED AND DETERIORATED, OPERABLE PANEL POTENTIALLY N STRUCTURALLY INTACT.
515	В	PAINTED	STL	CLEAR & OBSCURED	SASHES RUSTED AND DETERIORATED, OPERABLE PANEL POTENTIALLY IN STRUCTURALLY INTACT.
518	В	PAINTED	STL	OBSCURED	SASHES RUSTED AND DETERIORATED, OPERABLE PANEL POTENTIALLY N STRUCTURALLY INTACT, BROKEN GLAZING
521	В	PAINTED	STL	WIRE/OBSCURED	SASHES RUSTED AND DETERIORATED, OPERABLE PANEL POTENTIALLY NO STRUCTURALLY INTACT, BROKENMISSING GLAZING
524	В	PAINTED	STL	CLEAR & OBSCURED	SASHES RUSTED AND DETERIORATED, OPERABLE PANEL POTENTIALLY NI STRUCTURALLY INTACT.
530	В	PAINTED	STL	OBSCURED	SASHES RUSTED AND DETERIORATED, OPERABLE PANEL POTENTIALLY N STRUCTURALLY INTACT, BROKEN GLAZING
533	В	PAINTED	STL	OBSCURED	SASHES RUSTED AND DETERIORATED, OPERABLE PANEL POTENTIALLY NO STRUCTURALLY INTACT, BROKEN GLAZING
536	В	PAINTED	STL		SASHES RUSTED AND DETERIORATED, OPERABLE PANEL POTENTIALLY NO STRUCTURALLY INTACT.
539	В	PAINTED	STL	WIRE/OBSCURED	SASHES RUSTED AND DETERIORATED, OPERABLE PANEL POTENTIALLY NO STRUCTURALLY INTACT, BROKEN GLAZING
542	В	PAINTED	STL	CLEAR & OBSCURED	SASHES RUSTED AND DETERIORATED, OPERABLE PANEL POTENTIALLY NO STRUCTURALLY INTACT, BROKEN GLAZING
545	В	PAINTED	STL	CLEAR	SASHES RUSTED AND DETERIORATED, OPERABLE PANEL POTENTIALLY NO STRUCTURALLY INTACT.
548	В	PAINTED	STL	WIRE/OBSCURED	SASHES RUSTED AND DETERIORATED, OPERABLE PANEL POTENTIALLY NO STRUCTURALLY INTACT.
551	В	PAINTED	STL	WIRE/OBSCURED	SASHES RUSTED AND DETERIORATED, OPERABLE PANEL POTENTIALLY NO STRUCTURALLY INTACT.
554	В	PAINTED	STL	WIRE/OBSCURED	SASHES RUSTED AND DETERIORATED, OPERABLE PANEL POTENTIALLY NO STRUCTURALLY INTACT.
557	В	PAINTED	STL	WIRE/OBSCURED	SASHES RUSTED AND DETERIORATED, OPERABLE PANEL POTENTIALLY NO STRUCTURALLY INTACT.
560	В	PAINTED	STL	WIRE/OBSCURED	SASHES RUSTED AND DETERIORATED, OPERABLE PANEL POTENTIALLY IN STRUCTURALLY INTACT.
563	В	PAINTED	STL	WIRE/OB\$CURED	SASHES RUSTED AND DETERIORATED, OPERABLE PANEL POTENTIALLY NO STRUCTURALLY INTACT.
566	В	PAINTED	STL	WIRE/OBSCURED	SASHES RUSTED AND DETERIORATED, OPERABLE PANEL POTENTIALLY NO STRUCTURALLY INTACT, BROKEN GLAZING
569	В	PAINTED	STL	WIRE/OBSCURED	SASHES RUSTED AND DETERIORATED, OPERABLE PANEL POTENTIALLY NO STRUCTURALLY INTACT.
572	В	PAINTED	STL	WIRE/OBSCURED	SASHES RUSTED AND DETERIORATED, OPERABLE PANEL POTENTIALLY NO STRUCTURALLY INTACT.
575	н	PAINTED	STL	WIRE/OBSCURED	SASHES RUSTED AND DETERIORATED, OPERABLE PANEL POTENTIALLY NO STRUCTURALLY INTACT.
578	Н	PAINTED	STL	WIRE/OBSCURED	SASHES RUSTED AND DETERIORATED, OPERABLE PANEL POTENTIALLY NO STRUCTURALLY INTACT, BROKEN GLAZING
581	D	PAINTED	STL	WIRE/OBSCURED	SASHES RUSTED AND DETERIORATED, OPERABLE PANEL POTENTIALLY NO STRUCTURALLY INTACT, BROKEN GLAZING
584	Н	PAINTED	STL	WIRE/OBSCURED	SASHES RUSTED AND DETERIORATED, OPERABLE PANEL POTENTIALLY NO STRUCTURALLY INTACT, BROKEN GLAZING
508 617	H	PAINTED	STL	WIRE/OBSCURED WIRE/OBSCURED	LIGHT RUST, APPEARS STRUCTURALLY INTACT SASHES RUSTED AND DETERIORATED, OPERABLE PANEL POTENTIALLY NO
620	Н	PAINTED	STL		STRUCTURALLY INTACT, BROKEN GLAZING SASHES RUSTED AND DETERIORATED, OPERABLE PANEL POTENTIALLY NO
323	н	PAINTED	STL		STRUCTURALLY INTACT, BROKEN GLAZING SASHES RUSTED AND DETERIORATED, OPERABLE PANEL POTENTIALLY NO
326	H	PAINTED	STL	4	STRUCTURALLY INTACT, BROKEN GLAZING SASHES RUSTED AND DETERIORATED, OPERABLE PANEL POTENTIALLY NO
329	Н	PAINTED	STL		STRUCTURALLY INTACT, BROKEN GLAZING SASHES RUSTED AND DETERIORATED, OPERABLE PANEL POTENTIALLY NO
32	P.3	PAINTED	STL		STRUCTURALLY INTACT, BROKEN GLAZING LIGHT RUST, APPEARS STRUCTURALLY INTACT
35	N	PAINTED	WD		SEVERE ROT DAMAGE AT EXTERIOR, MISSING GLAZING AND MULLIONS

WINDOW CONDITIONS - 3RD

					WINDOW CONDITIONS - 2ND
MARK	TYPE	Finish	MATERIAL	Glazing	CONDITION
-					
300	Т	PAINTED	STL	CLEAR	SASHES RUSTED AND DETERIORATED, OPERABLE PANEL POTENTIALLY NOT STRUCTURALLY INTACT.
303	Т	PAINTED	STL	CLEAR	SASHES RUSTED AND DETERIORATED, OPERABLE PANEL POTENTIALLY NOT STRUCTURALLY INTACT.
306	Т	PAINTED	STL	CLEAR	SASHES RUSTED AND DETERIORATED, OPERABLE PANEL POTENTIALLY NOT STRUCTURALLY INTACT, BROKEN GLAZING
309	Т	PAINTED	STL	OBSCURED	SASHES RUSTED AND DETERIORATED, OPERABLE PANEL POTENTIALLY NOT STRUCTURALLY INTACT, BROKEN GLAZING
312	8	PAINTED	STL	CLEAR	SASHES RUSTED AND DETERIORATED, OPERABLE PANEL POTENTIALLY NOT STRUCTURALLY INTACT.
315	В	PAINTED	STL	CLEAR & OBSCURED	SASHES RUSTED AND DETERIORATED, OPERABLE PANEL POTENTIALLY NOT STRUCTURALLY INTACT
318	В	PAINTED	STL	CLEAR	SASHES RUSTED AND DETERIORATED, OPERABLE PANEL POTENTIALLY NOT STRUCTURALLY INTACT.
321	В	PAINTED	STL	CLEAR	SASHES RUSTED AND DETERIORATED, OPERABLE PANEL POTENTIALLY NOT STRUCTURALLY INTACT, BROKEN GLAZING
324	В	PAINTED	STL	CLEAR & OBSCURED	SASHES RUSTED AND DETERIORATED, OPERABLE PANEL POTENTIALLY NOT STRUCTURALLY INTACT.
327	В	PAINTED	STL	CLEAR & OBSCURED	SASHES RUSTED AND DETERIORATED, OPERABLE PANEL POTENTIALLY NOT STRUCTURALLY INTACT, BROKEN GLAZING
333	В	PAINTED	STL	OBSCURED	SASHES RUSTED AND DETERIORATED, OPERABLE PANEL POTENTIALLY NOT STRUCTURALLY INTACT.
336	В	PAINTED	STL	CLEAR & OBSCURED	SASHES RUSTED AND DETERIORATED, OPERABLE PANEL POTENTIALLY NOT STRUCTURALLY INTACT.
339	В	PAINTED	STL	OBSCURED	SASHES RUSTED AND DETERIORATED, OPERABLE PANEL POTENTIALLY NOT STRUCTURALLY INTACT, BROKEN GLAZING
342	В	PAINTED	STL	WIRE/OBSCURED	
345	В	PAINTED	STL	OBSCURED	SASHES RUSTED AND DETERIORATED, OPERABLE PANEL POTENTIALLY NOT STRUCTURALLY INTACT, BROKEN GLAZING
357	В	PAINTED	STL	WIRE/OBSCURED	
360	В	PAINTED	STL	OBSCURED	SASHES RUSTED AND DETERIORATED, OPERABLE PANEL POTENTIALLY NOT STRUCTURALLY INTACT, BROKEN GLAZING
363	В	PAINTED	STL	WIRE/OBSCURED	
366	В	PAINTED	STL	WIRE/OBSCURED	SASHES RUSTED AND DETERIORATED, OPERABLE PANEL POTENTIALLY NOT STRUCTURALLY INTACT, BROKEN GLAZING
369	8	PAINTED	STL	WIRE/OBSCURED	SASHES RUSTED AND DETERIORATED, OPERABLE PANEL POTENTIALLY NOT STRUCTURALLY INTACT, BROKEN GLAZING
372	Т	PAINTED	STL	WIRE/OBSCURED	SASHES RUSTED AND DETERIORATED, OPERABLE PANEL POTENTIALLY NOT STRUCTURALLY INTACT, BROKEN GLAZING
375	Н	PAINTED	STL	WIRE/OBSCURED	SASHES RUSTED AND DETERIORATED, OPERABLE PANEL POTENTIALLY NOT STRUCTURALLY INTACT
378	н	PAINTED	STL	WIRE/OBSCURED	SASHES RUSTED AND DETERIORATED, OPERABLE PANEL POTENTIALLY NOT STRUCTURALLY INTACT, FAN PENETRATION
381	D	PAINTED	STL	WIRE/OBSCURED	SASHES RUSTED AND DETERIORATED, OPERABLE PANEL POTENTIALLY NOT STRUCTURALLY INTACT, BROKEN GLAZING
384	Н	PAINTED	STL	WIRE/08SCURED	SASHES RUSTED AND DETERIORATED, OPERABLE PANEL POTENTIALLY NOT STRUCTURALLY INTACT, BROKEN GLAZING
199	K	PAINTED	WD	OBSCURED	SEVERE ROT DAMAGE AT INTERIOR, EXTERIOR NOT VISIBLE, BROKEN GLAZING
102	K	PAINTED	WD	CLEAR & OBSCURED	ORGINAL WINDOW REMOVED AND REPLACED WITH WOOD DOUBLE HUNG
405	K	PAINTED	WD	OBSCURED	SEVERE ROT DAMAGE AT INTERIOR, EXTERIOR NOT VISIBLE
108	P.3	PAINTED	STL	WIRE/OBSCURED	LIGHT RUST, APPEARS STRUCTURALLY INTACT, BROKEN GLAZING
111	P.3	PAINTED	STL	WIRE/OBSCURED	LIGHT RUST, APPEARS STRUCTURALLY INTACT, BROKEN GLAZING
117	J	PAINTED	STL	WIRE/OBSCURED	SASHES RUSTED AND DETERIORATED, OPERABLE PANEL POTENTIALLY NOT STRUCTURALLY INTACT, BROKEN GLAZING
120	J	PAINTED	STL	WIRE/OBSCURED	SASHES RUSTED AND DETERIORATED, OPERABLE PANEL POTENTIALLY NOT STRUCTURALLY INTACT, BROKEN GLAZING
23	J	PAINTED	STL		SASHES RUSTED AND DETERIORATED, OPERABLE PANEL POTENTIALLY NOT STRUCTURALLY INTACT, BROKEN GLAZING
26	J	PAINTED	STL		SASHES RUSTED AND DETERIORATED, OPERABLE PANEL POTENTIALLY NOT STRUCTURALLY INTACT, BROKEN GLAZING
29	J		STL	WIRE/OBSCURED	SASHES RUSTED AND DETERIORATED, OPERABLE PANEL POTENTIALLY NOT STRUCTURALLY INTACT, BROKEN GLAZING
132	P.3	PAINTED	STL		LIGHT RUST APPEARS STOLICTURALLY MITACT PROVEN OLATRIC

.,,,					STRUCTURALLY INTACT	1000		7.414120	1 011	OBSCORED	STRUCTURALLY INTACT, BROKEN GLAZING
115	В	PAINTED	STL	OBSCURED	SASHES RUSTED AND DETERIORATED, OPERABLE PANEL POTENTIALLY NOT STRUCTURALLY INTACT.	312	2 8	PAINTED	STL	CLEAR	SASHES RUSTED AND DETERIORATED, OP STRUCTURALLY INTACT.
118	В	PAINTED	STL	OBSCURED	SASHES RUSTED AND DETERIORATED, OPERABLE PANEL POTENTIALLY NOT STRUCTURALLY INTACT.	315	В	PAINTED	STL	CLEAR & OBSCURED	SASHES RUSTED AND DETERIORATED, OP STRUCTURALLY INTACT.
121	В	PAINTED	STL	OBSCURED	SASHES RUSTED AND DETERIORATED, OPERABLE PANEL POTENTIALLY NOT STRUCTURALLY INTACT.	318	В	PAINTED	STL	CLEAR	SASHES RUSTED AND DETERIORATED, OP STRUCTURALLY INTACT.
124	В	PAINTED	STL	OBSCURED	SASHES RUSTED AND DETERIORATED, OPERABLE PANEL POTENTIALLY NOT STRUCTURALLY INTACT.	321	В	PAINTED	STL	CLEAR	SASHES RUSTED AND DETERIORATED, OP STRUCTURALLY INTACT, BROKEN GLAZING
127	В	PAINTED	STL	OBSCURED	SASHES RUSTED AND DETERIORATED, OPERABLE PANEL POTENTIALLY NOT STRUCTURALLY INTACT.	324	В	PAINTED	STL	CLEAR & OBSCURED	SASHES RUSTED AND DETERIORATED, OP STRUCTURALLY INTACT.
130	В	PAINTED	STL	OBSCURED	SASHES RUSTED AND DETERIORATED, OPERABLE PANEL POTENTIALLY NOT- STRUCTURALLY INTACT, BROKEN GLAZING	327		PAINTED	STL	CLEAR & OBSCURED	SASHES RUSTED AND DETERIORATED, OP STRUCTURALLY INTACT, BROKEN GLAZING
133	В	PAINTED	STL	OBSCURED	SASHES RUSTED AND DETERIORATED, OPERABLE PANEL POTENTIALLY NOT STRUCTURALLY INTACT.	333	В	PAINTED	STL	OBSCURED	SASHES RUSTED AND DETERIORATED, OP STRUCTURALLY INTACT.
136	В	PAINTED	STL	OBSCURED	SASHES RUSTED AND DETERIORATED, OPERABLE PANEL POTENTIALLY NOT STRUCTURALLY INTACT, BROKEN GLAZING	336		PAINTED	STL	CLEAR & OBSCURED	SASHES RUSTED AND DETERIORATED, OP STRUCTURALLY INTACT.
139	В	PAINTED	STL	OBSCURED	SASHES RUSTED AND DETERIORATED, OPERABLE PANEL POTENTIALLY NOT STRUCTURALLY INTACT.	339		PAINTED		OBSCURED	SASHES RUSTED AND DETERIORATED, OP- STRUCTURALLY INTACT, BROKEN GLAZING
142	В	PAINTED	STL	OBSCURED	SASHES RUSTED AND DETERIORATED, OPERABLE PANEL POTENTIALLY NOT STRUCTURALLY INTACT, BROKEN GLAZING	342	В	PAINTED	STL	WIRE/OBSCURED	
154	В	PAINTED	STL		STRUCTURALLY INTACT, BROKEN GLAZING	345		PAINTED		OBSCURED	SASHES RUSTED AND DETERIORATED, OPI STRUCTURALLY INTACT, BROKEN GLAZING
157	В	PAINTED	STL		STRUCTURALLY INTACT.	357	В	PAINTED	110000	WIRE/OBSCURED	SASHES RUSTED AND DETERIORATED, OP- STRUCTURALLY INTACT, BROKEN GLAZING
160	8	PAINTED	STL		SASHES RUSTED AND DETERIORATED, OPERABLE PANEL POTENTIALLY NOT STRUCTURALLY INTACT, BROKEN GLAZING	360	В	PAINTED	STL	OBSCURED	SASHES RUSTED AND DETERIORATED, OPI STRUCTURALLY INTACT, BROKEN GLAZING
163	В	PAINTED	STL		STRUCTURALLY INTACT, BROKEN GLAZING	363	В	PAINTED	STL	WIRE/OBSCURED	SASHES RUSTED AND DETERIORATED, OPE STRUCTURALLY INTACT, BROKEN GLAZING
166	В	PAINTED	STL		SASHES RUSTED AND DETERIORATED, OPERABLE PANEL POTENTIALLY NOT STRUCTURALLY INTACT, BROKEN GLAZING	366	В	PAINTED	STL	WIRE/OBSCURED	SASHES RUSTED AND DETERIORATED, OPE STRUCTURALLY INTACT, BROKEN GLAZING
169	В	PAINTED	STL	WIRE/OBSCURED	STRUCTURALLY INTACT, BROKEN GLAZING	369	8	PAINTED	STL	WIRE/OBSCURED	SASHES RUSTED AND DETERIORATED, OPE STRUCTURALLY INTACT, BROKEN GLAZING
175	G	PAINTED	STL	CLEAR	SASHES RUSTED AND DETERIORATED, OPERABLE PANEL POTENTIALLY NOT STRUCTURALLY INTACT, BROKEN GLAZING	372	Т	PAINTED	STL	WIRE/OBSCURED	SASHES RUSTED AND DETERIORATED, OPE STRUCTURALLY INTACT, BROKEN GLAZING
178	G	PAINTED	STL		SASHES RUSTED AND DETERIORATED, OPERABLE PANEL POTENTIALLY NOT STRUCTURALLY INTACT, BROKEN GLAZING	375	Н	PAINTED	STL	WIRE/OBSCURED	SASHES RUSTED AND DETERIORATED, OPE
181	E	PAINTED	STL		SASHES RUSTED AND DETERIORATED, OPERABLE PANEL POTENTIALLY NOT STRUCTURALLY INTACT, BROKEN GLAZING	378	н	PAINTED	STL	WIRE/OBSCURED	SASHES RUSTED AND DETERIORATED, OPE STRUCTURALLY INTACT, FAN PENETRATION
184	G	PAINTED	STL	WIRE/OBSCURED	SASHES RUSTED AND DETERIORATED, OPERABLE PANEL POTENTIALLY NOT STRUCTURALLY INTACT, BROKEN GLAZING	381	D	PAINTED	STL	WIRE/OBSCURED	SASHES RUSTED AND DETERIORATED, OPE STRUCTURALLY INTACT, BROKEN GLAZING
187	M	PAINTED	STL		LIGHT RUST, APPEARS STRUCTURALLY INTACT	384	Н	PAINTED	STL	WIRE/OBSCURED	SASHES RUSTED AND DETERIORATED, OPE
190	M	PAINTED	STL		LIGHT RUST, APPEARS STRUCTURALLY INTACT	000			1110		STRUCTURALLY INTACT, BROKEN GLAZING
193	M	PAINTED	STL	OBSCURED OBSCURED	LIGHT RUST, APPEARS STRUCTURALLY INTACT	399 402	100		WD	OBSCURED	SEVERE ROT DAMAGE AT INTERIOR, EXTER
199 202	ĸ	PAINTED	WD	OBSCURED	SEVERE ROT DAMAGE AT INTERIOR, EXTERIOR NOT VISIBLE SEVERE ROT DAMAGE AT INTERIOR, EXTERIOR NOT VISIBLE, BROKEN GLAZING	402	K	PAINTED	WD	OBSCURED OBSCURED	ORGINAL WINDOW REMOVED AND REPLACE
205	к	PAINTED	WD	OBSCURED	SEVERE ROT DAMAGE AT INTERIOR, EXTERIOR NOT VISIBLE	408	P.3	PAINTED			SEVERE ROT DAMAGE AT INTERIOR, EXTER
208	K	PAINTED	WD	OBSCURED	EXTERIOR AND INTERIOR NOT VISIBLE	411	P.3	PAINTED	STL	WIRE/OBSCURED	LIGHT RUST, APPEARS STRUCTURALLY INT. LIGHT RUST, APPEARS STRUCTURALLY INT.
211	P.3	PAINTED	STL	and the second of the second o	LIGHT RUST, APPEARS STRUCTURALLY INTACT, BROKEN/MISSING GLAZING	417	J	PAINTED	STL	WIREIOBSCURED	SASHES RUSTED AND DETERIORATED, OPE
214	P.3	PAINTED	STL	OBSCURED	LIGHT RUST, APPEARS STRUCTURALLY INTACT, BROKEN GLAZING	1	, v	AUVILL	SIL	WIKE/OBSCOKED	STRUCTURALLY INTACT, BROKEN GLAZING
217	G	PAINTED	STL	OBSCURED	SASHES RUSTED AND DETERIORATED, OPERABLE PANEL POTENTIALLY NOT STRUCTURALLY INTACT, BROKEN GLAZING	420	J	PAINTED	STL	WIRE/OBSCURED	SASHES RUSTED AND DETERIORATED, OPE STRUCTURALLY INTACT, BROKEN GLAZING
220	G	PAINTED	STL	OBSCURED	SASHES RUSTED AND DETERIORATED, OPERABLE PANEL POTENTIALLY NOT STRUCTURALLY INTACT.	423	J	PAINTED	STL	WIRE/OBSCURED	SASHES RUSTED AND DETERIORATED, OPE STRUCTURALLY INTACT, BROKEN GLAZING
223	G	PAINTED	STL	WIRE/OBSCURED	SASHES RUSTED AND DETERIORATED, OPERABLE PANEL POTENTIALLY NOT STRUCTURALLY INTACT, BROKEN GLAZING	426	J	PAINTED	STL	WIRE/OBSCURED	SASHES RUSTED AND DETERIORATED, OPE STRUCTURALLY INTACT, BROKEN GLAZING
226	G	PAINTED	STL	OBSCURED	SASHES RUSTED AND DETERIORATED, OPERABLE PANEL POTENTIALLY NOT STRUCTURALLY INTACT, MISSING GLAZING	429	J	PAINTED	STL	WIRE/OBSCURED	SASHES RUSTED AND DETERIORATED, OPE STRUCTURALLY INTACT, BROKEN GLAZING
		PAINTED	STL	OBSCURED	SASHES RUSTED AND DETERIORATED, OPERABLE PANEL POTENTIALLY NOT	432	P.3	PAINTED	STL	WIRE/OBSCURED	LIGHT RUST, APPEARS STRUCTURALLY INTO
232	A	PAINTED									

WINDOW CONDITIONS - BASEMENT								
MARK	TYPE	T	4	Glazing				
		Finish	MATERIAL		CONDITION			
6	s	PAINTED	STL	OBSCURED	CONDITION NOT OBSERVED			
7	S	PAINTED	STL	OBSCURED	CONDITION NOT OBSERVED			
9	S	PAINTED	STL	OBSCURED	CONDITION NOT OBSERVED			
20	P2	UNPAINTED	CONC	OBSCURED	BROKEN GLASS BLOCK AND CHIPPED MORTOR			
23	P.1	UNPAINTED	CONC	OBSCURED	BROKEN GLASS BLOCK AND CHIPPED MORTOR			
29	P-1	UNPAINTED	CONC	OBSCURED	BROKEN GLASS BLOCK AND CHIPPED MORTOR			
32	P.1	UNPAINTED	CONC	OBSCURED	CONDITION NOT OBSERVED			
33	R	PAINTED	STL	OBSCURED	CONDITION NOT OBSERVED			

WINDOW CONDITIONS - 1ST

CONDITION

SASHES RUSTED AND DETERIORATED, OPERABLE PANEL POTENTIALLY NOT STRUCTURALLY INTACT, BROKEN GLAZING SASHES RUSTED AND DETERIORATED, OPERABLE PANEL POTENTIALLY NOT STRUCTURALLY INTACT, BROKEN GLAZING

SASHES RUSTED AND DETERIORATED, OPERABLE PANEL POTENTIALLY NOT STRUCTURALLY INTACT.

SASHES RUSTED AND DETERIORATED, OPERABLE PANEL POTENTIALLY NOT

Finish

OBSCURED

OBSCURED

OBSCURED

103 B PAINTED STL

109 B PAINTED STL

112 B PAINTED STL

GENERAL NOTES - EXISTING WINDOWS

- CONDITION SURVEY BASED ON OBSERVATION OF EXTERIOR AND INTERIOR CONDITIONS. WINDOWS OBSERVED WERE CHOSEN AT RANDOM USING THE GENERAL PROGRESSION OF EVER THIRD WINDOW AS AN EXHIBIT
- ALMOST ALL OF THE ORIGINAL WINDOWS HAVE OBSCURED GLAZING AND IS SUSPECTED TO CONTAIN HAZADOUS GLAZING MATERIALS. THE GLAZING WILL NEED TO BE REMOVED AND ALL LEAD PAINT MITIGATED TO ENSURE THE HEALTH SAFETY AND WELFARE OF RESIDENTIAL OCCUPANTS.
- THE BASEMENT WINDOWS HAVE NOT BEEN OBSERVED. THE CONDITION IS ASSUMED TO BE, AT MINIMUM, IN SIMILAR CONDITION AS THE OTHER WOOD WINDOWS.
- THE MANUFACTURER INFORMATION INCLUDED IN THESE DOCUMENTS DEPICTS THE PROPOSED TYPICAL CONDITION FOR REPLACEMENT. ALL FINAL WINDOW DESIGN MUST BE FIFLD VERTIFED AND SCHEDULED TO MATCH THE WINDOW SURVEY LOCATION AND SUBMITTED TO ARCHITECT FOR REVIEW PRIOR TO FABRICATION.

Author CHECKED BY Checker

EXISTING CONDITIONS