

CITY OF RACINE

General Application Form

Department of City Development 730 Washington Ave., Rm. 102

Racine, WI 53403 Phone: 262-636-9151

Fax: 262-635-5347

| Type of Reviews | S | | | |
|-------------------------|---------------------------|--|--|--|
| ☐ 2035 Comprehe | nsive Plan | ☐ Certified Survey Map | □ De | esign Review (\$0 Fee) |
| Amendment (\$0 | Fee) | (\$170 + \$50 per lot) | ☐ Re | esearch Request (\$0 Fee) |
| Administrative R | Review | ☑ Conditional Use Permits | ☐ Re | ezoning (\$830 Fee) |
| (\$0 Fee) | | (\$695 Fee) | | |
| APPLICANT NAME: SE | KAO. INC. | | | |
| ADDRESS: STREET: 161 | | сıту: Racine | Sī | TATE: WI ZIP: 53406 |
| TELEPHONE: 262-886- | | L PHONE: 262-210-5599 | | |
| EMAIL: barb.waltma | | | | |
| | D 0.1 | | | |
| AGENT NAME (IF APPLIC | | D : | | 11/1 52406 |
| ADDRESS: STREET 2000 | | city: Racine | | E: <u>WI</u> zIP: <u>53406</u> |
| TELEPHONE: 262-886- | | L PHONE: <u>262-770-8178</u> | <u> </u> | |
| EMAIL: doakes@awo | oakes.com | | | |
| DDODEDTY ADDDESS /ES | a. 6006 - 21st Stre | et. Racine. WI 53406 | | |
| CURRENT ZONING: B- | | et. Raeme. W1 99400 | | |
| CURRENT/MOST RECEN | | eineke Car Care | | 1 |
| PROPOSED USE: Mein | | | | |
| PROPOSED ZONING (onl | | Osed Car Bares | | |
| • | | ed for CSM, Rezoning and Co | mnrehensive Plan A | mendments): |
| N/A | b TAXILLY (only require | d for colvi, Rezoling and ce | inprenensive rian A | <u></u> |
| | SIVE PLAN DESIGNATIO | N: (only for comp plan ame | ndments) N/A | |
| | | ON: (only for comp plan am | The Contract of the Contract o | |
| | | , | , | |
| Are you the owner of th | e property included in | the area of the requested zo | oning? | |
| ⊠ Yes □ 1 | No 🗆 Option | to Purchase Lea | ise | |
| | | | | |
| *NOTE: The owner of the | ne property (if different | than the applicant) must si | ign this application. | |
| OWNER & APPLICANT A | LITHODIZATION | | | |
| | | ents made by myself and cor | estituting part of this | application are true and |
| | | ation of any information on | - · | |
| | · | pproved, it is issued on the | | _ |
| * · | | rmit(s) or other type of perr | • | The state of the s |
| | | | | |
| | | oproval. The applicant/owner all on-site and off-site impro | | |
| plan: | : for the completion of | an on-site and on-site impro | veillents as shown ai | nd approved on the final |
| Pian. |) | [[][][] | | |
| Owner (s) Signature: | any | Calo | Date ⁻ | 1/2/19 |
| Print Name: Daniel (| Dakes | | | |
| Analisans (a) Class | | 9 | | |
| | | | Date | |
| Print Name: | | | | |



CITY OF RACINE

Conditional Use Permit Checklist

Department of City Development 730 Washington Ave., Rm. 102

Racine, WI 53403

Phone: 262-636-9151 Fax: 262-635-5347

Applicant

☑ General Development Application Form

SITE PLAN(S)

- MUST BE DRAWN TO AN ENGINEER OR ARCHITECT SCALE AND PROVIDE THE FOLLOWING INFORMATION (Unless otherwise noted, provide 3 copies of the Site Plan. If full-scale architectural plans are submitted, one copy of the plans shall be no larger than 11"x17". The reduced copy does not need to be to scale. NOTE: Submit 8 sets for Planned Developments). Complete, scaled and legible plans are required. If you are unable to provide this information addressing all the requirements below, you may wish to contact an architect to assist you in creating your documents for submittal.

Plans Should Include

Clearly identify the lot(s) being requested for Conditional Use. Include accurate lot dimensions, and the location
of the lot in relation to adjacent streets, curbs, and surrounding lots. Provide a North arrow, and note the scale
used (i.e.: 1"-20').

☑ Structure Location

- Location of all structures on the lot. All structures shall be drawn and dimensioned. Show the distance of the structures from property lines, as well as the distance from other buildings on the lot.

☑ Ingress/Egress

- Show the access drives, and their widths, into the site. Also show any recorded ingress/egress or other easements (check with the Register of Deeds for this information). Show location and width of all easements within the site and at the property line/s.

☑ Parking Lot

- Show all on-site parking areas with stall sizes. Legal stall size is 9' wide by 19' deep. Indicate the width of all drive aisles accessing the parking. Show the curb line, wheel stops, any loading areas on the building/site, and location of handicapped spaces.

☑ Trash/Utility Areas

- Show the location of trash or utility areas and how they will be, or are, screened (i.e.: fencing with slats, wood fencing, landscaping, etc.). Trash bins/dumpsters require 6' opaque screening with closing gates.

☑ Fencing/Walls

Show the location and height of all existing and proposed fencing or walls and what materials they are/will be made of. Show any outdoor patio areas, even if located below a canopy.

☑ Outdoor Lighting

Show all existing and proposed outdoor lighting located on the building and on the site itself. Provide the height of the lights by measuring from grade to the top of the fixture. Identify the type of fixture and angle/direction of the light beam. If an under-lit canopy is requested, a photometric plan prepared by a licensed company is required with the submittal.

■ Landscaping

Provide a landscaping plan showing all existing and proposed landscaping. Indicate the plant species, sizes (caliper or gallon), and location of plantings on the site plan. Indicate and identify if existing landscaping is proposed to be altered. Species to be non-invasive, salt tolerant and drought resistant.

| K | Surface Details |
|---|--|
| | - Indicate the surface detail of all outdoor areas (i.e.: grass, gravel, asphalt, concrete, pavers, etc.). |
| | Sewer/Water - Existing |
| | - Show the location of all sewer, water and storm sewer lines (only for new construction or project where there is |
| | an increase in impervious surface). |
| | Signage |
| | - Provide proposed signage information for the project. (Note: This is required if signage is the reason for the |
| | conditional use. If not, signage may be approved separately from the Conditional Use review unless otherwise |
| | indicated by Staff). |
| M | Drainage/Grading |
| | - Show on-site surface water drainage and grading, and building and ground elevations (new construction only). |
| X | FLOOR PLANS & ELEVATION DRAWINGS TO SCALE: (Unless otherwise noted, provide 3 copies, One of the three |
| | copies shall be no larger than 11"x17". The reduced copy does not need to be to scale. (NOTE: Submit 8 sets for |
| | Planned Developments): If you are unable to provide this information addressing all the requirements below, you |
| | may wish to contact an architect to assist you in creating your plans. |
| Ø | Scaled Floor Plans |
| | - Provide an 'as-built' copy, and a 'proposed build out' copy if any changes to the internal layout are requested. |
| | Scaled dimensions of all interior areas shall be provided. These areas may include office spaces, general work |
| | areas, storage areas, waiting rooms, repair areas, bathrooms, garage areas, kitchen areas, etc. |
| | Architecture |
| | - Provide detail of existing architectural treatments on the entire building exterior. If remodeling, repairing, or new |
| | construction work is part of this proposal, also provide information on proposed colors, materials, and extra |
| | features such as awnings, canopies, porticos, etc. Identify what materials the building will be constructed of (i.e.: |
| _ | masonry, brick, etc.). Indicate any proposed changes to the materials (including the roof). |
| | OTHER INFORMATION |
| | Written Description |
| | Provide a DETAILED, WRITTEN description of the proposed business. Provide information about the type of |
| | business, machinery involved, type of product produced and/or services being provided, noise issues, parking |
| _ | data, etc. Additional information may be requested throughout the review process. |
| П | Deliveries Discuss anticipated truck traffic and size of trucks as well as fragments of deliveries and viels are |
| | Discuss anticipated truck traffic and size of trucks, as well as frequency of deliveries and pick-ups. Maintenance Plan |
| ш | Provide a site maintenance plan, indicating who will be responsible for things such as grass cutting, garbage and |
| | litter removal, enforcement of parking standards, clearing of snow, daily site up-keep, etc. If these duties will be |
| | contracted out, include a copy of the contractor's proposal or agreement. |
| | Indicate any plans for future expansion, if applicable |
| × | Review Fee |
| | A non-refundable review fee of \$695.00, payable by cash or check, made out to the City of Racine shall be |
| | submitted with the complete submittal+. If this request is being made in conjunction with a rezoning request, |
| | the combined fee is \$1,120.00. |
| | :::::::::::::::::::::::::::::::::::::: |
| | I certify that all items checked above have been provided. I understand that not providing all of this information may |
| | result in an incomplete application and persy the consideration of my project for approval. |
| | SIGNATURE: J-7-19 |
| | SIGNATURE: MIM / WILL DATE: |

Brief Business Plan for Citi Auto Sales


We believe there is a need in Racine City especially on Highway 31 for a large selection of quality budget used cars, and Citi Auto Sales will sell this kind of vehicles at a competitive pricing.


Citi Auto Sales will be buying their cars from various auctions to bring the savings to the customers.


Citi Auto Sales will be operating with a general manager, sales person, and service person. The company is planning to have approximately 40 cars ready for sale and planning to sell 15 cars per month, 200 cars per year.

Hours of operation will be Monday to Friday 8 to 6, Saturday 8-4 and Sunday closed. Our showroom and office will be used for showing vehicles for sale and to conduct auto sales transactions. The repairs will be made at the Meineke location.

We plan to add an addition to the existing building for a showroom and office for automobile vehicle sales with a parking lot to the east. The location address is $6006 - 21^{st}$ Street, Suite B, Racine, Wisconsin 53406.

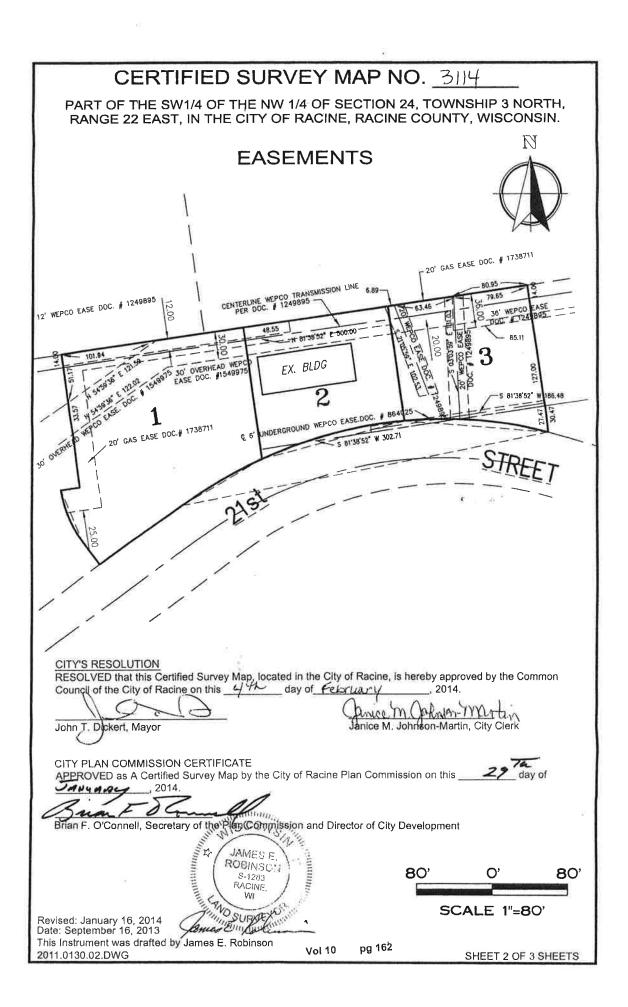

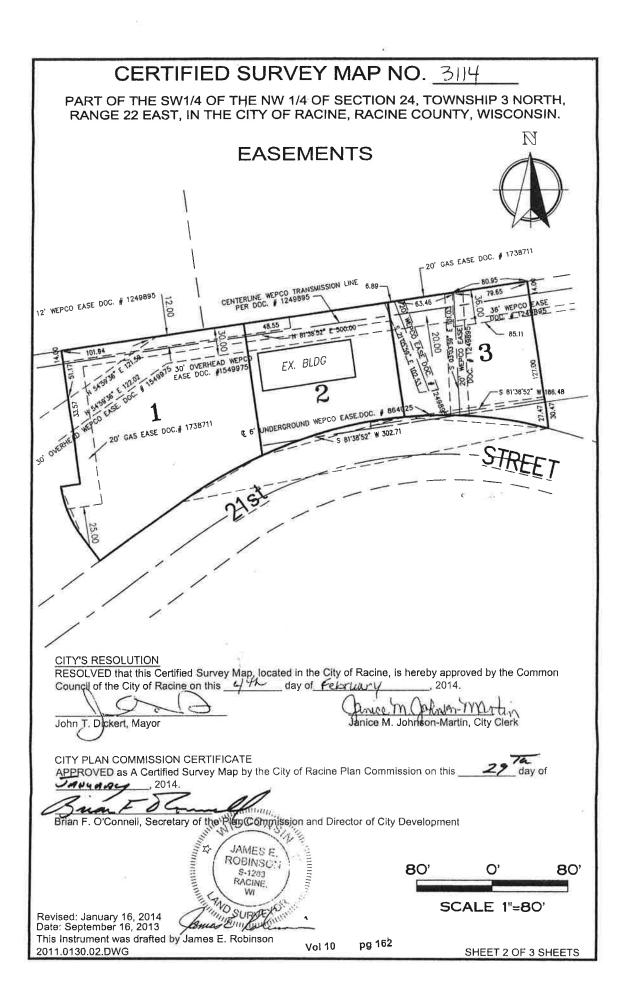

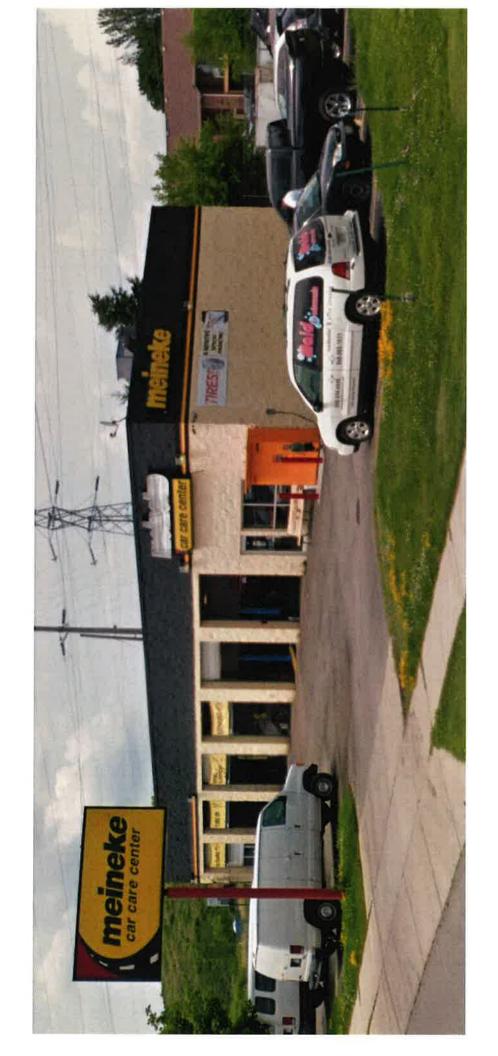

PROJECT INFORMATION:

CLIENT:

SEKAO, INC. 2000 OAKES ROAD RACINE, INI 53406

GENERAL CONTRACTOR:

SEKAO, INC. 2000 OAKES ROAD RACINE, WI 53406

HVAC CONTRACTOR:

ELECTRICAL CONTRACTOR:

PLUMBING CONTRACTOR:

PROJECT SITE



Vicinity Map:

NOT TO SCALE

GENERAL NOTES:

- PROJECT SCOPE TO CONSIST OF NEW FREE STANDING STEEL FRAMED BUILDING WITH
- 2. INTERIOR WALL AND CEILING FINISH MATERIALS SHALL BE CLASSIFIED IN ACCORDANCE WITH ASTM E 84 OR UL 723. THEIR FLAME SPREAD AND SMOKE-DEVELOPED INDEXES

CLASS A: FLAME SPREAD INDEX 0-25; SMOKE-DEVELOPED INDEX 0-450. CLASS B: FLAME SPREAD INDEX 26-75; SMOKE-DEVELOPED INDEX 0-450. CLASS C: FLAME SPREAD INDEX 76-200; SMOKE DEVELOPED INDEX 0-450.

- 3. INTERIOR WALL AND CEILING FINISHES SHALL COMPLY WITH TABLE 803,9 WITH A MINIMUM RATING OF CLASS C.
- 4. INTERIOR FLOOR FINISH AND FLOOR GOVERING MATERIALS SHALL COMPLY WITH THE
- 5. FIRE EXTINGUISHERS WITH A MINIMUM 2-A RATING PER NEPA 10 SHALL BE PROVIDED. INSTALLED AND MAINTAINED AS REQUIRED BY LOCAL GOVERNING CODES. THE NUMBER AND TYPE OF EXTINGUISHER SHALL BE DETERMINED BY THE LOCAL FIRE DEPARTMENT AND THE LANDLORD'S INSURANCE CARRIER, MAXIMUM TRAVEL DISTANCE TO EXTINGUISHERS SHALL BE 75 FEET. FIRE EXTINGUISHERS SHALL BE FURNISHED AND INSTALLED BY THE GENERAL CONTRACTOR.
- THE ARCHITECT / ENGINEER MAINTAINS NO RESPONSIBILITY FOR THE GENERAL CONTRACTOR, SUBCONTRACTORS OR THOSE WORKING IN SUCH CAPACITIES, FOR THE MEANS OR METHODS USED, OR LACK THEREOF, IN THE EXECUTION OF THE WORK AND SAFETY PROCEDURES AND PRECAUTIONS TAKEN AT THE PROJECT SITE.
- 7. ALL CONSTRUCTION SHALL BE PERFORMED IN STRICT CONFORMANCE WITH ALL APPLICABLE STATE AND LOCAL BUILDING CODES.
- 8. CONTRACTORS SHALL COMPLY WITH THE LATEST (OSHA) OCCUPATIONAL SAFETY AND HEALTH ACT REQUIREMENTS.
- 9. CONTRACTORS SHALL ASSUME FULL RESPONSIBILITY UNRELIEVED BY REVIEW OF SHOP DRAWINGS NOR BY SUPERVISION OR PERIODIC OBSERVATION OF CONSTRUCTION FOR COMPLIANCE WITH THE CONTRACT DOCUMENTS - FOR DIMENSIONS TO BE CONFIRMED AND CORRELATED ON THE JOB SITE AND BETWEEN INDIVIDUAL DRAWINGS OR SETS OF DRAWINGS; FOR FABRICATION PROCESSES AND CONSTRUCTION TECHNIQUES (INCLUDING EXCAVATION, SHORING, BRACING, SCAFFOLDING, FORMMORK ERECTION, ETC.); FOR COORDINATION OF THE VARIOUS TRADES; FOR SAFE CONDITIONS ON THE JOB SITE; AND FOR PROTECTION OF THE PEOPLE AND PROPERTY AT THE JOB
- VARIATIONS IN FIELD CONDITIONS RELATIVE TO THE CONTRACT DOCUMENTS SHALL BE REPORTED TO THE ARCHITECT / ENGINEER. WORK SHALL NOT PROGRESS UNTIL WRITTEN PERMISSION FROM THE ARCHITECT / ENGINEER IS OBTAINED.
- 11. THE INFORMATION CONTAINED ON THE DRAWINGS IS IN ITSELF INCOMPLETE, AND YOLD UNLESS USED IN CONJUNCTION WITH ALL THE SPECIFICATIONS, TRADE PRACTICES, APPLICABLE STANDARDS GODES ETG. INCORPORATED THEREIN BY REFERENCE, OF WHICH THE CONTRACTOR CERTIFIES KNOWLEDGE BY SIGNING THE CONTRACT.
- 12. UNLESS OTHERWISE NOTED, ALL DETAILS, SECTIONS AND NOTES ON THE DRAWINGS ARE INTENDED TO BE TYPICAL FOR SIMILAR SITUATIONS AND CONDITIONS ELSEWHERE
- 13. DRAWINGS ARE NOT TO BE USED FOR SHOP DETAILING OR FOR CONSTRUCTION UNLESS SPECIFICALLY STAMPED BY THE ARCHITECT / ENGINEER ON THE DRAWINGS "FOR DETAILING" OR "FOR CONSTRUCTION". THESE DRAWINGS ARE NOT TO BE REPRODUCED FOR THE PURPOSE OF USING THEM AS SHOP DRAWINGS.
- ARCHITECT / ENGINEER'S REVIEW OF DRAWINGS PREPARED BY THE CONTRACTORS, SUPPLIERS, ETC., ARE ONLY FOR CONFORMANCE WITH THE DESIGN CONCEPT. CONSTRUCTION SHALL NOT START WITHOUT SAID REVIEW, AND ONLY SHOP DRAWINGS STAMPED BY THE ARCHITECT / ENGINEER WILL BE ALLOWED AT THE JOB SITE.
- SEE ARCHITECTURAL, STRUCTURAL, MECHANICAL, ELECTRICAL AND PLUMBING DRAWINGS FOR ADDITIONAL OPENINGS, SLEEVES, EQUIPMENT PADS, DEPRESSIONS, CURBS, INSERTS, FLOOR FINISHES AND OTHER EMBEDDED ITEMS.
- 16. UNLESS OTHERWISE NOTED OR SHOWN, THE GENERAL CONTRACTOR SHALL BE RESPONSIBLE FOR COORDINATING THE LOCATION AND PLACEMENT OF ANY INSERTS, HANGERS, ANCHOR BOLTS, HOLES OR PIPE SLEEVES THAT ARE REQUIRED BY THE MECHANICAL, ELECTRICAL OR PLUMBING EQUIPMENT
- 17. ALL DIMENSIONS ON STRUCTURAL DRAWINGS ARE TO BE CHECKED BY THE CONTRACTORS AGAINST ARCHITECTURAL, MECHANICAL, ELECTRICAL AND PLUMBING DRAWINGS. CONTRACTORS SHALL BE FULLY RESPONSIBLE FOR CONFIRMING AND CORRELATING ALL DIMENSIONS ON THE JOB SITE AND BETWEEN INDIVIDUAL DRAWINGS AND RESPECTIVE TRADES.
- 18. THIS PROJECT IS BEING DESIGNED AND CONSTRUCTED UTILIZING A DESIGN / BUILD DELIVERY PROCESS FOR THE MAJOR SUBCONTRACTOR TRADES OF MECHANICAL (HVAC), ELECTRICAL, PLUMBING AND FIRE PROTECTION SYSTEMS. EACH SUBCONTRACTOR IS RESPONSIBLE TO SUBMIT PLANS AND OBTAIN PERMITS FOR THEIR RESPECTIVE SPECIALTY TRADES. GENERAL CONTRACTOR AND SUBCONTRACTORS SHALL COORDINATE ALL WORK WITHIN THE SCOPE OF THIS PROJECT FOR SYSTEMS INSTALLATION, INTERFERENCE CONTROL AND PROJECT CONSTRUCTION SCHEDULE.

CODE INFORMATION:

REFERENCED CODES ARE: IBC 2015; IEBC 2015 ICC/ANSI A111.1-2009

USE AND OCCUPANCY CLASSIFICATION

(SECTION 304) BUSINESS GROUP B GROUP 5-1 (SECTION 311)

TYPE OF CONSTRUCTION:

NEW CONSTRUCTION TYPE IIIB

CLASSIFICATION OF WORK NEW CONSTRUCTION (IBC)

ALLOWABLE BUILDING HEIGHT (TABLES 504.3 & 504.4):

OCCUPANCY GROUP B 55 FEET/ 3 STORIES OCCUPANCY GROUP 5-1 55 FEET/ 2 STORIES

ALLOWABLE BUILDING AREA (TABLE 506.2):

OCCUPANCY GROUP B TYPE IIIB CONSTRUCTION OCCUPANCY GROUP 5-1 TYPE IIIB CONSTRUCTION 19,000 SQ. FT. OF FLOOR AREA PER STORY 17,500 SQ. FT. OF FLOOR AREA PER STORY

ACTUAL BUILDING AREA:

EXISTING FIRST FLOOR 4,000 GROSS SQ. FT. FIRST FLOOR ADDITION TOTAL FLOOR AREA: 640 GROSS SQ. FT. 4,640 GROSS SQ. FT.

BUILDING IS NOT EQUIPPED WITH AN AUTOMATIC SPRINKLER SYSTEM PER NFPA 13, MINIMUM THRESHOLD FOR PROTECTION BY AN AUTOMATIC SPRINKLER SYSTEM: LESS THAN 12,000 SQ. FT. - IBC 903.2)

FIRE-RESISTANCE RATING REQUIREMENTS (TABLES 601 & 602):

PRIMARY STRUCTURAL FRAME O HOUR RATING BEARING WALLS (EXTERIOR) 2 HOUR RATING BEARING WALLS (INTERIOR) O HOUR RATING

NONBEARING WALLS & PARTITIONS (EXTERIOR) FIRE SEPARATION DISTANCE 0-5 FT

1 HOUR RATING (GROUP B) 2 HOUR RATING (GROUP (S-1) FIRE SEPARATION DISTANCE 5-10 FT 1 HOUR RATING (GROUP B & S-1) 1 HOUR RATING (GROUP B & 5-1)

FIRE SEPARATION DISTANCE 10-30 FT FIRE SEPARATION DISTANCE 30 FT+ 0 HOUR RATING (GROUP B & S-1) NONBEARING WALLS & PARTITIONS (INTERIOR) 0 HOUR RATING

FLOOR CONSTRUCTION & SECONDARY MEMBERS O HOUR RATING ROOF CONSTRUCTION & SECONDARY MEMBERS 0 HOUR RATING

FIRST FLOOR OCCUPANCY GROUP B = 41 OCCUPANTS (@100 GROSS SQ. FT.) FIRST FLOOR OCCUPANCY GROUP S-1 = 16 OCCUPANTS (@300 GROSS SQ. FT.)

SHEET INDEX:

T1.0 TITLE SHEET

PROPOSED FOUNDATION PLAN A1.0 A1.1 PROPOSED FLOOR PLAN

A2.1 PROPOSED ELEVATIONS

WALL SECTIONS

i-tec-ture

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6006 21st STREET RACINE, WISCONSIN 53406

Sheet Title

NEW ADDITION FOR:

TITLE SHEET

07/03/19 Date:


19-121

Job No. Sheet No

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14)*



FOUNDATION PLAN

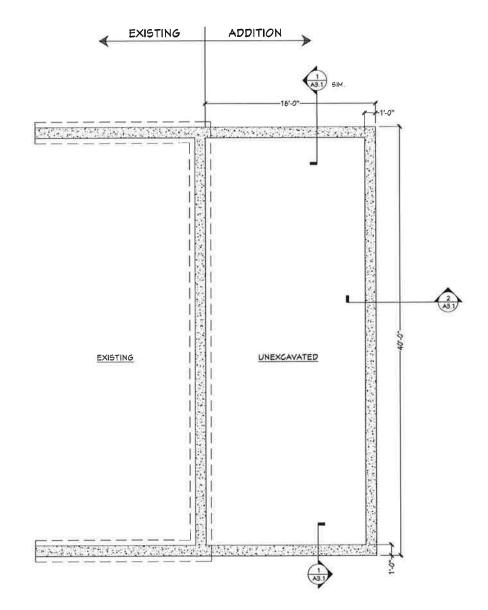

PLAN NORTH



TRUE NORTH

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6006 21st STREET RACINE, WISCONSIN 53406

Project:

NEW ADDITION FOR:


Sheet Title: PROPOSED FOUNDATION PLAN

Job No.

CITY REVIEW SET - (07-03-14)

07/03/19 19-121

A1.0

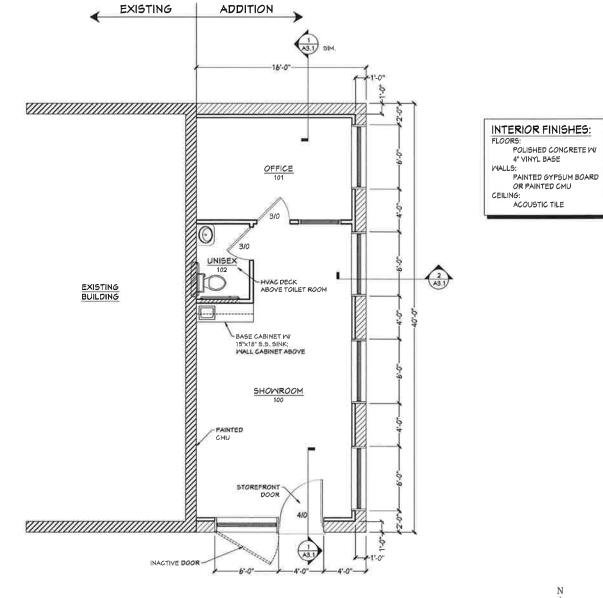

 $\underbrace{ \ \ \, \mathop{\text{PROPOSED}}_{\mathcal{A}1.1} \, \mathop{\text{PLOOR}}_{\mathcal{X}^*=\, 1^{\text{t}}0^*} }$

PLAN NORTH



TRUE NORTH

NEW ADDITION FOR: CITY AUTO SALES

·i-tec-ture

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6006 21st STREET RACINE, WISCONSIN 53406

Project:

PROPOSED FLOOR PLAN


SET - (07-03-14)*

REVIEW

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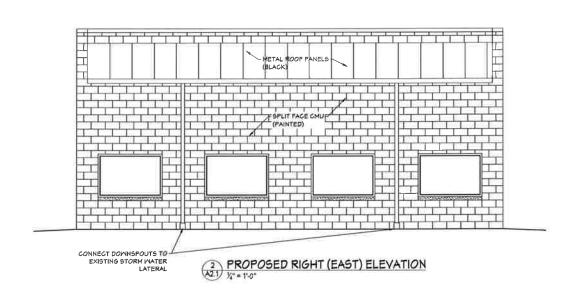
07/03/19


19-121 Job No. Sheet No.

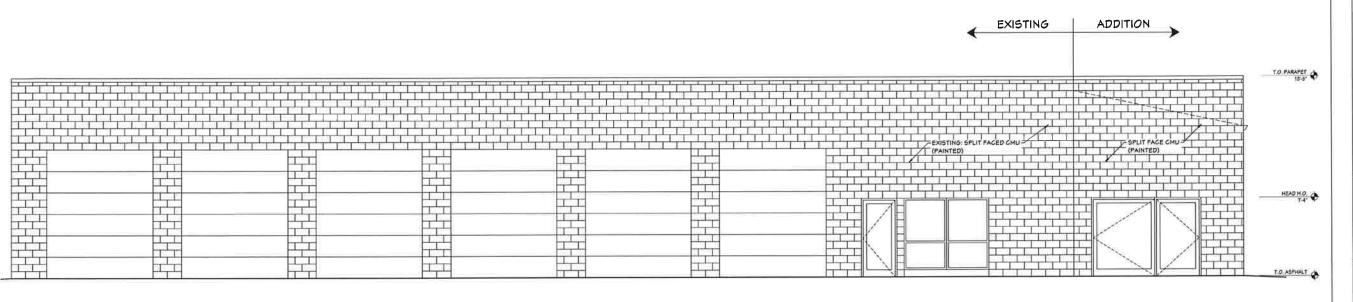

PROPOSED FRONT (SOUTH) ELEVATION

EXTERIOR COLORS OF ADDITION SHALL MATCH EXISTING BUILDING INCLUDING BLACK COLOR BAND AT TOP OF WALLS



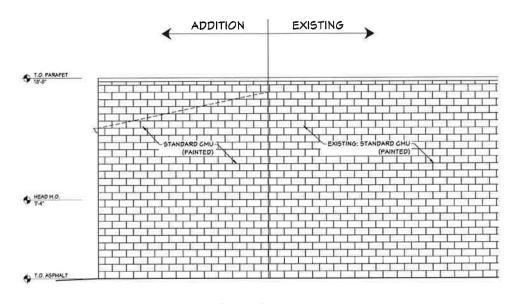

PROPOSED REAR (NORTH) ELEVATION

Cell: (414) 303-5489 Email: koz@kozitecture ·i-tec-ture David J. Koscielniak AIA ALA 12310 West Waterford Avenue Greenfield, Misconsin 53228

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NEW ADDITION FOR:

6006 21st STREET RACINE, MISCONSIN 53406

Project:

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5ET

REVIEW

·CITY


PROPOSED

ELEVATIONS

Revisions:


07/03/19 19-121

Sheet No.

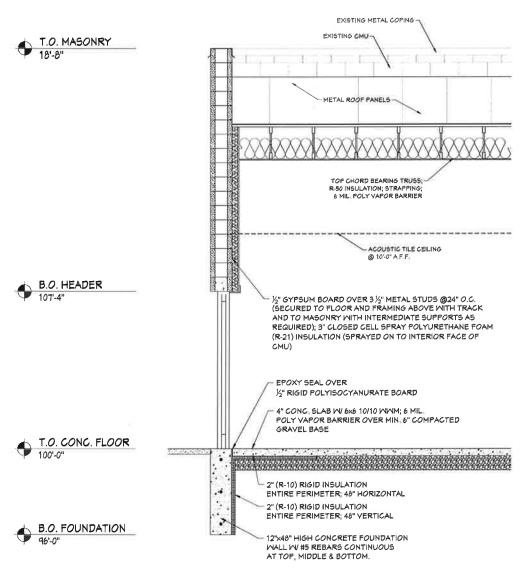

MALL SECTION

A3.1) ½" = 11.0"

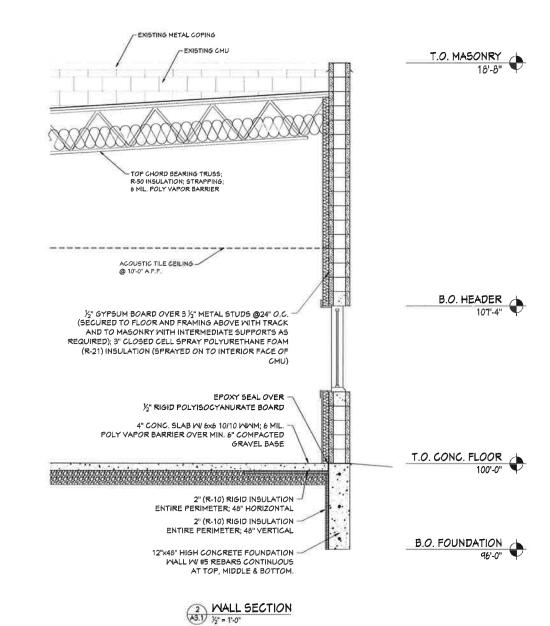

(01-03-14)* 9E1 REVIEW CITY

·i-tec-ture

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NEW ADDITION FOR:

Project:

WALL SECTIONS

07/03/19 19-121

Job No.


| Luminaire | Schedu | le | | | | | | |
|-----------|--------|---------|-------------|-------|-------------|------------|-------------------------------------|--|
| Symbol | Qty | Label | Arrangement | LMF | Lum. Lumens | Lum. Watts | Part Number | |
| -m- | 1 | T4-2 | BACK-BACK | 1.000 | 22330 | 166 | OSQ-A-NM-4ME-T-57K-xx-xx + OSQ-DAxx | |
| | 1 | X-3M-8L | SINGLE | 1.000 | 8475 | 71 | XSPW-B-WM-3ME-8L-40K-UL-xx | |

| Calculation Summary | | | | | | |
|---------------------|-------|------|-----|-----|---------|---------|
| Label | Units | Avg | Max | Min | Avg/Min | Max/Min |
| CalcPts 1 | Fc | 0.62 | 8.4 | 0.0 | N.A. | N.A. |
| Property Line | Fc | 0.22 | 0.4 | 0.0 | N.A. | N.A. |

Pole Schedule
(1) PS4S22C2xx (22' X 4" X .125" STEEL SQUARE POLE)
Proposed poles meet 120 MPH sustained winds.

Additional Equipment: (2) OSQ-DAxx (Direct Arm Mount)

*** CUSTOMER TO VERIFY ORDERING INFORMATION AND CATALOGUE NUMBER PRIOR TO PLACING ORDER ***

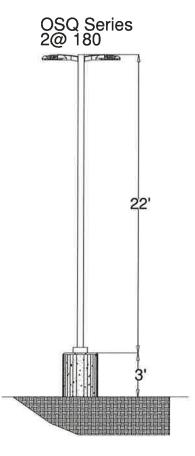

0.0 0.0 0.0 0.0 0.0 0.0 0.0 0.0 0.0 0.0 0.0 0.1 5 101.3 0.9 0.7 0.7 1.0 1.1 0.9 1.0 1.2 1.1 0.9 0.6

CREE . LIGHTING

A COMPANY OF IDEAL INDUSTRIES, INC.

1 Washington Ave, Racine, WI 53406 https://creelighting.com - (800) 236-6

are based on project parameters provided to Cree Lighting used occeptancion with numbars test procedures conducted under blackably conditions. Actual project conditions differing from these design parameters may affect field results. The custome is responsible for verifying dimensional accuracy acrows the compliance with any applicable electrical, lighting or empty code. Project Name: City Car Sales 6006 21st St, Racine, WI 53406


SR-37567


Footcandles calculated at grade


Filename: 190627MK1BAF.AGI

Layout By: Ben Foster Scale 1" = 16'


Date:6/27/2019 0 32 64

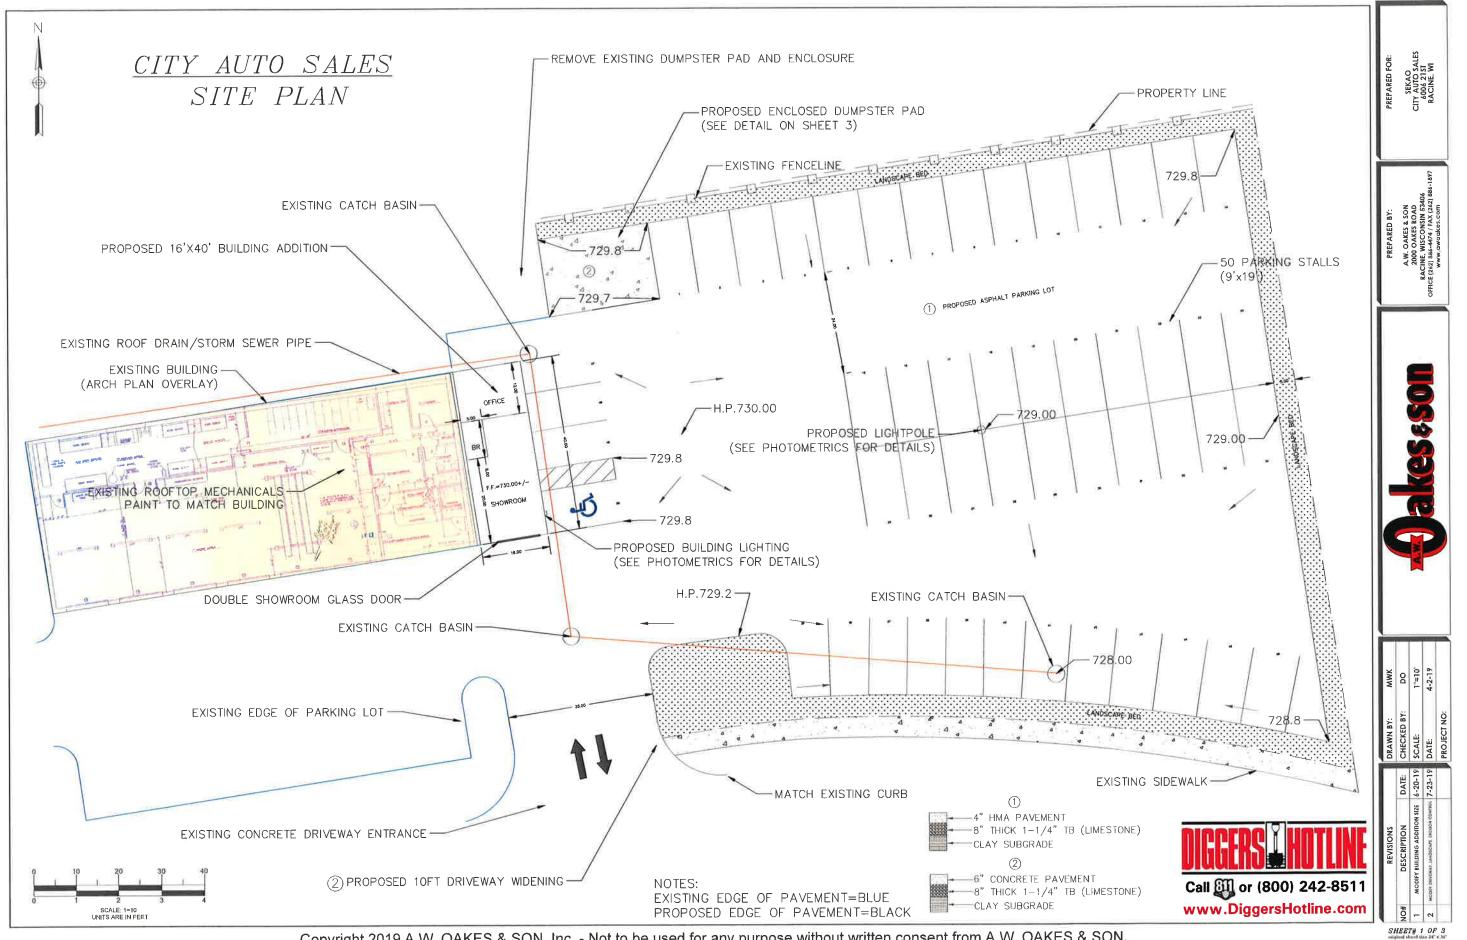

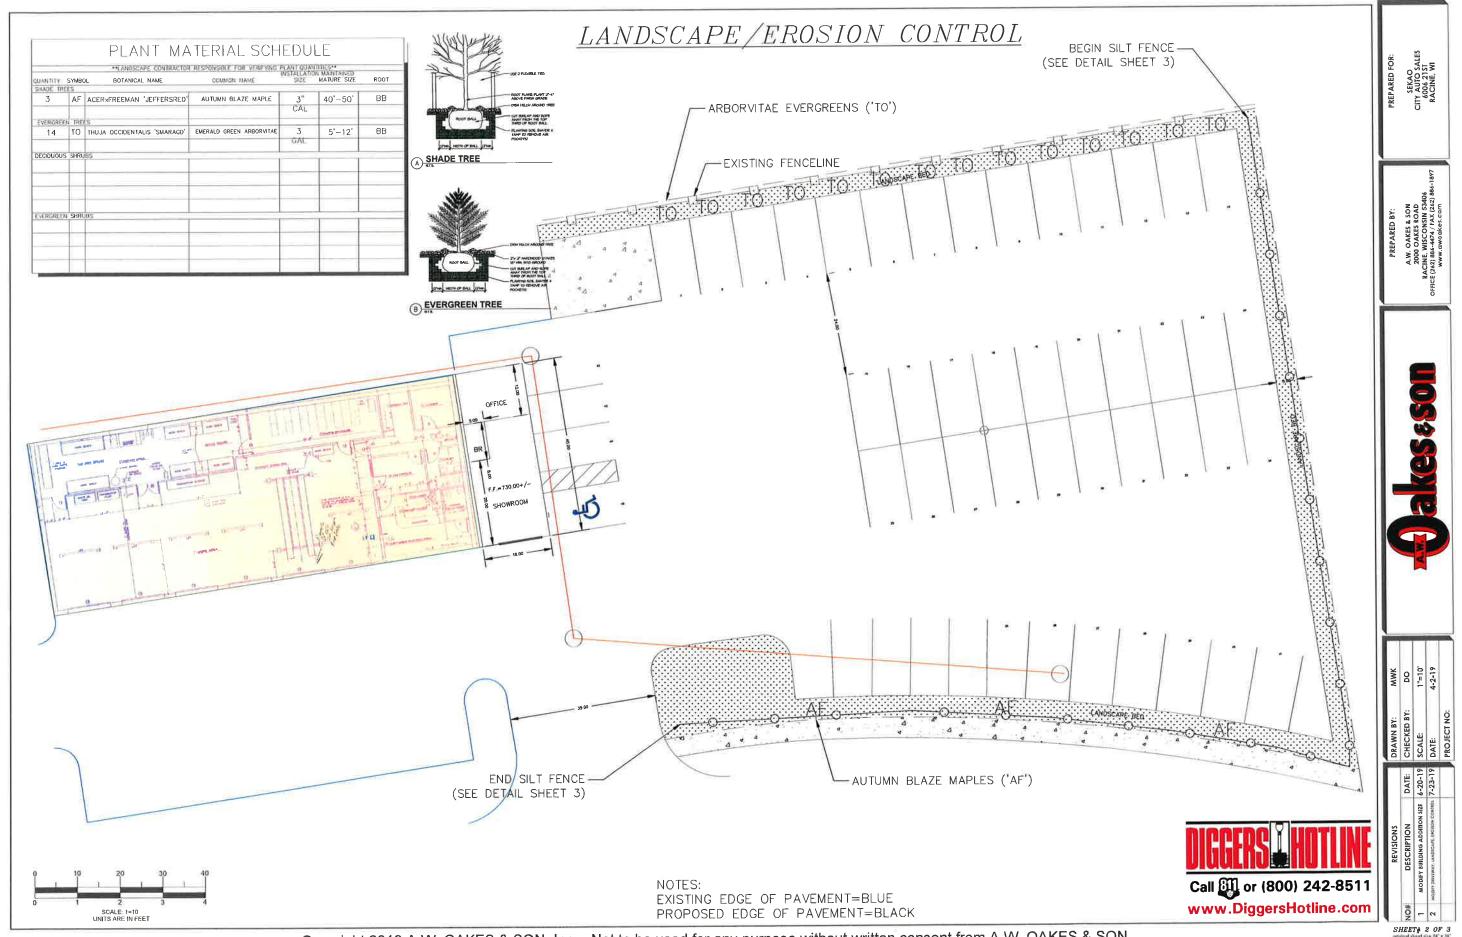

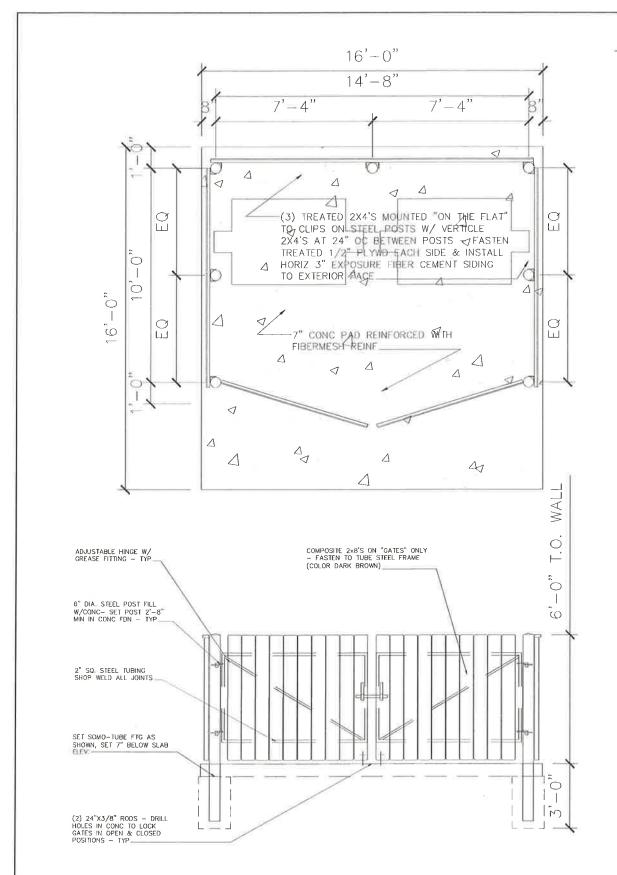

DETAILS

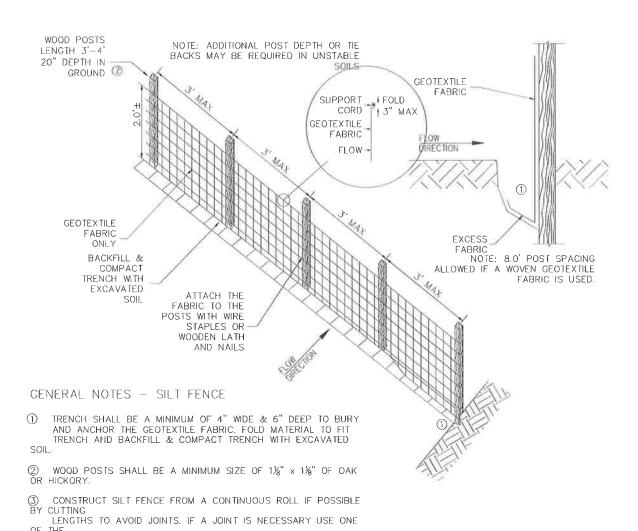

3 TYPICAL SILT FENCE DETAIL NOT TO SCALE

FOLLOWING TWO METHODS: A) TWIST METHOD -- OVERLAP THE END POSTS AND TWIST, OR ROTATE, AT LEAST 180 DEGREES, B) HOOK METHOD -- HOOK THE END OF EACH SILT FENCE LENGTH.

Call or (800) 242-8511
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